
(B) MAX. LENGTH = 45 M MIN. LENGTH = 36 M BUILDING HEIGHT ZONE 6 MAX HEIGHT 16 M MIN HEIGHT 8 M **3** ⑱ MAX. WIDTH = 31 M MIN. WIDTH = 27 M PLAN MAX. HEIGHT 25.2 M AOD (3 storeys) MIN. HEIGHT 17.2 M AOD **GROUND LEVEL** 9.2 M AOD **ELEVATION A-A**

TECH HUB BUILDING ZONE

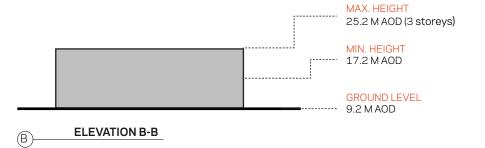

MAXIMUM GROSS EXTERNAL AREA OF BUILDING ZONE DEFINED IN **DEVELOPMENT SPECIFICATION**

NOTE: HEIGHT FIGURES INDICATE MAXIMUM HEIGHT TO TOP OF ROOF PARAPETS OR EAVES. REFER TO DESIGN CODE FOR RESTRICTIONS ON THE EXTENT & LOCATION OF PROJECTIONS SUCH AS ROOF PLANT, FLUES, ETC. HEIGHTS INDICATED AS AOD BASED ON A TYPICAL SITE LEVEL OF 9.20M AOD.

Project

REEC Richmond Education & Enterprise Campus

Prepared for

Richmond-upon-Thames College

Client Location

Richmond upon Thames College | Egerton Road | Twickenham | Middlesex | TW2 7SJ



HOK Qube, 90 Whitfield Street London, W1T 4EZ, UK t +44 (0) 20 7636 2006 f +44 (0) 20 7636 1987

All reproduction & intellectual property rights reserved © 2014

FUSION PM

Project Management
9 Springfield Lyons Approach, Chelmsford,
Essex, CM2 5LB

VALIDUS LM


Project Management 90 Long Acre, Covent Garden, London WC2E 9RZ

CASCADE CONSULTING

CGMS CONSULTING

Planning Consultants 140 London Wall, London EC2 5DN

KEYPLAN

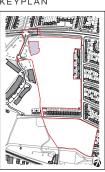

Do not scale dimensions from drawings

No.	Description	Date
-	OPA SUBMISSION	2015.06.15


Drawn by: æ Reviewed Scale: 1:1000 @ A3 Project No: 12.33036

Sheet Title:

Tech Hub Development Zone Building Zone Parameter Plan 2

Original drawing is A3. Do not scale this drawing.

Sheet Number:

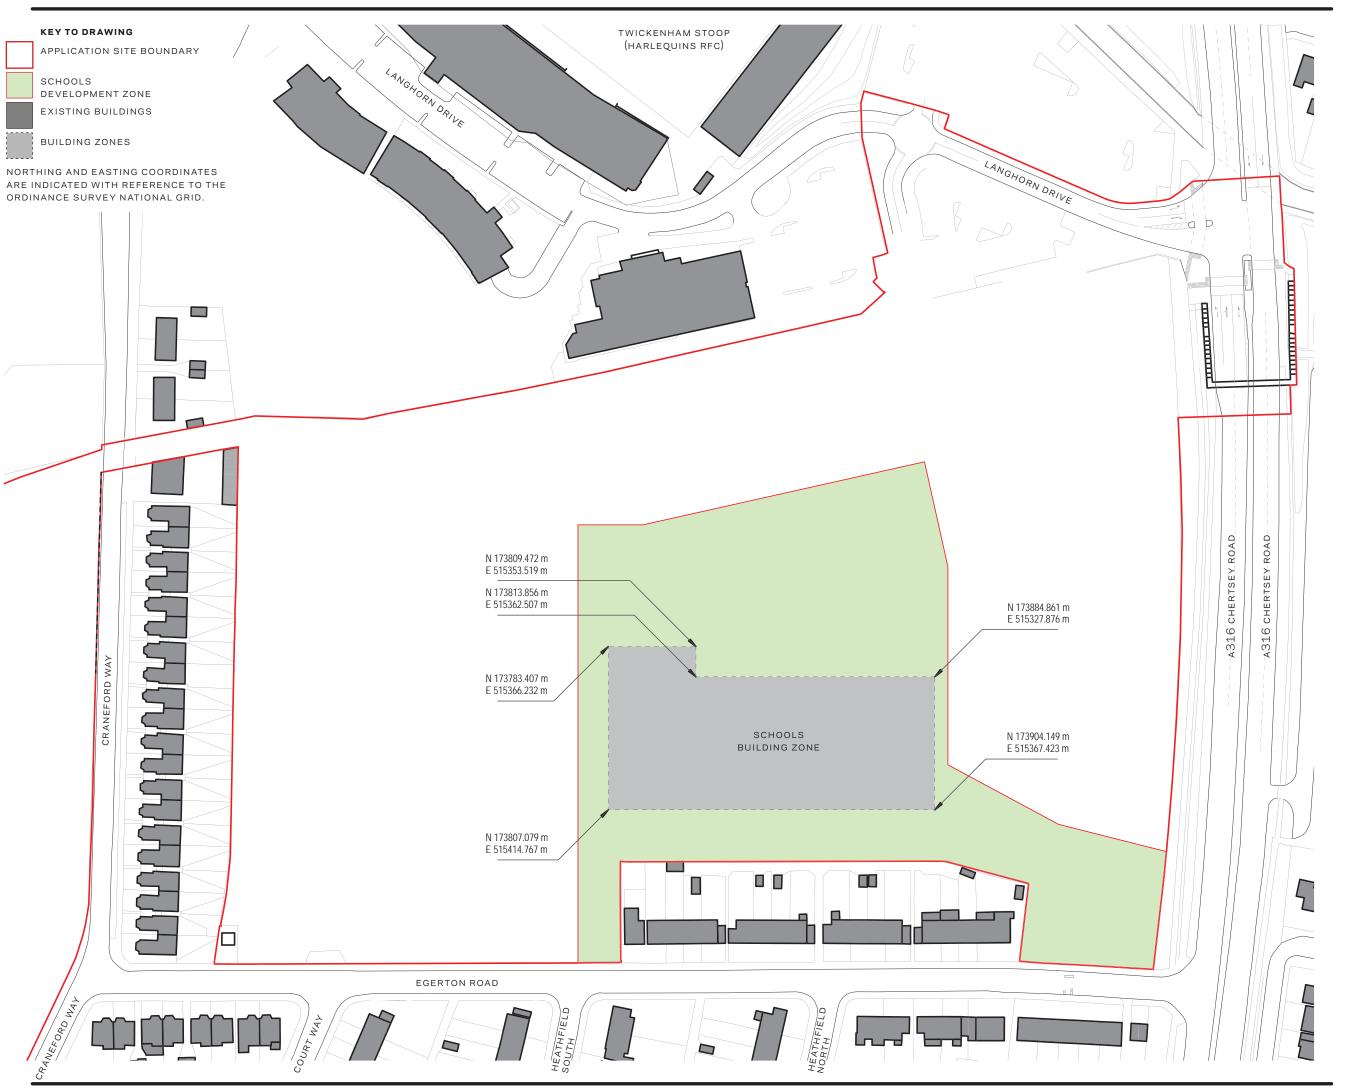

Project

REEC Richmond Education & **Enterprise Campus**

Prepared for

Richmond-upon-Thames College

Client Location

Richmond upon Thames College | Egerton Road | Twickenham | Middlesex | TW2 7SJ



HOK Qube, 90 Whitfield Street London, W1T 4EZ, UK t +44 (0) 20 7636 2006 f +44 (0) 20 7636 1987

All reproduction & intellectual property rights reserved © 2014

FUSION PM Project Manageme

9 Springfield Lyons Approach, Chelmsford, Essex, CM2 5LB

VALIDUS LM

Project Management 90 Long Acre, Covent Garden, London WC2E 9RZ

CASCADE CONSULTING

Environmental Consultants
The Courtyard, Ladycross Business Park,
Hollow Lane, Dormansland, Surrey RH7 6PB

CGMS CONSULTING

Planning Consultants 140 London Wall, London EC2 5DN



No.	Description	Date
-	OPA SUBMISSION	2015.06.15

Drawn by: Scale: 1:1250 @ A3
Project No: 12.33036

Sheet Title:

Schools Development Zone Building Zone Parameter Plan 1

Original drawing is A3. Do not scale this drawing.

MAX. WIDTH = 44 M MIN. WIDTH = 35 M B MAX. LENGTH = 29 M MIN. LENGTH = 18 M **N** BUILDING HEIGHT ZONE 7 MAX. WIDTH = 32 M BUILDING HEIGHT ⑧ ZONE 5 MIN. WIDTH = 22 M **-**♠ MAX. WIDTH = 54 M MIN. WIDTH = 45 MPLAN MAX. HEIGHT (ZONE 7) 27.7 M AOD (4 storeys) MAX. HEIGHT (ZONE 5) 23.7 M AOD (3 storeys) MIN. HEIGHT (ZONES 5&7) 20.7 M AOD **GROUND LEVEL** 9.2 M AOD **ELEVATION A-A**

SCHOOLS BUILDING ZONE

MAXIMUM GROSS EXTERNAL AREA OF BUILDING ZONE DEFINED IN **DEVELOPMENT SPECIFICATION**

NOTE: HEIGHT FIGURES INDICATE MAXIMUM HEIGHT TO TOP OF ROOF PARAPETS OR EAVES. REFER TO DESIGN CODE FOR RESTRICTIONS ON THE EXTENT & LOCATION OF PROJECTIONS SUCH AS ROOF PLANT, FLUES, ETC. HEIGHTS INDICATED AS AOD BASED ON A TYPICAL SITE LEVEL OF 9.20M AOD.

MAX. HEIGHT (ZONE 7)

27.7 M AOD (4 storeys)

MAX. HEIGHT (ZONE 5)

23.7 M AOD (3 storeys)

20.7 M AOD

9.2 M AOD

ELEVATION B-B

GROUND LEVEL

MIN. HEIGHT (ZONES 5&7)

Project

REEC Richmond Education & **Enterprise Campus**

Prepared for

Richmond-upon-Thames College

Client Location

Richmond upon Thames College | Egerton Road | Twickenham | Middlesex | TW2 7SJ



HOK Qube, 90 Whitfield Street London, W1T 4EZ, UK t +44 (0) 20 7636 2006 f +44 (0) 20 7636 1987

All reproduction & intellectual property rights reserved © 2014

FUSION PM

9 Springfield Lyons Approach, Chelmsford, Essex, CM2 5LB

VALIDUS LM

Project Management 90 Long Acre, Covent Garden, London WC2E 9RZ

CASCADE CONSULTING

Environmental Consultants
The Courtyard, Ladycross Business Park,
Hollow Lane, Dormansland, Surrey RH7 6PB

CGMS CONSULTING

Planning Consultants 140 London Wall, London EC2 5DN

KEYPLAN



Do not scale dimensions from drawings

- OPA SUBI	MISSION		201	5.06.1


Drawn by: 1:1000 @ A3 Scale: Project No: 12.33036

Sheet Title:

Schools Development Zone Building Zone Parameter Plan 2

Original drawing is A3. Do not scale this drawing.

Sheet Number:

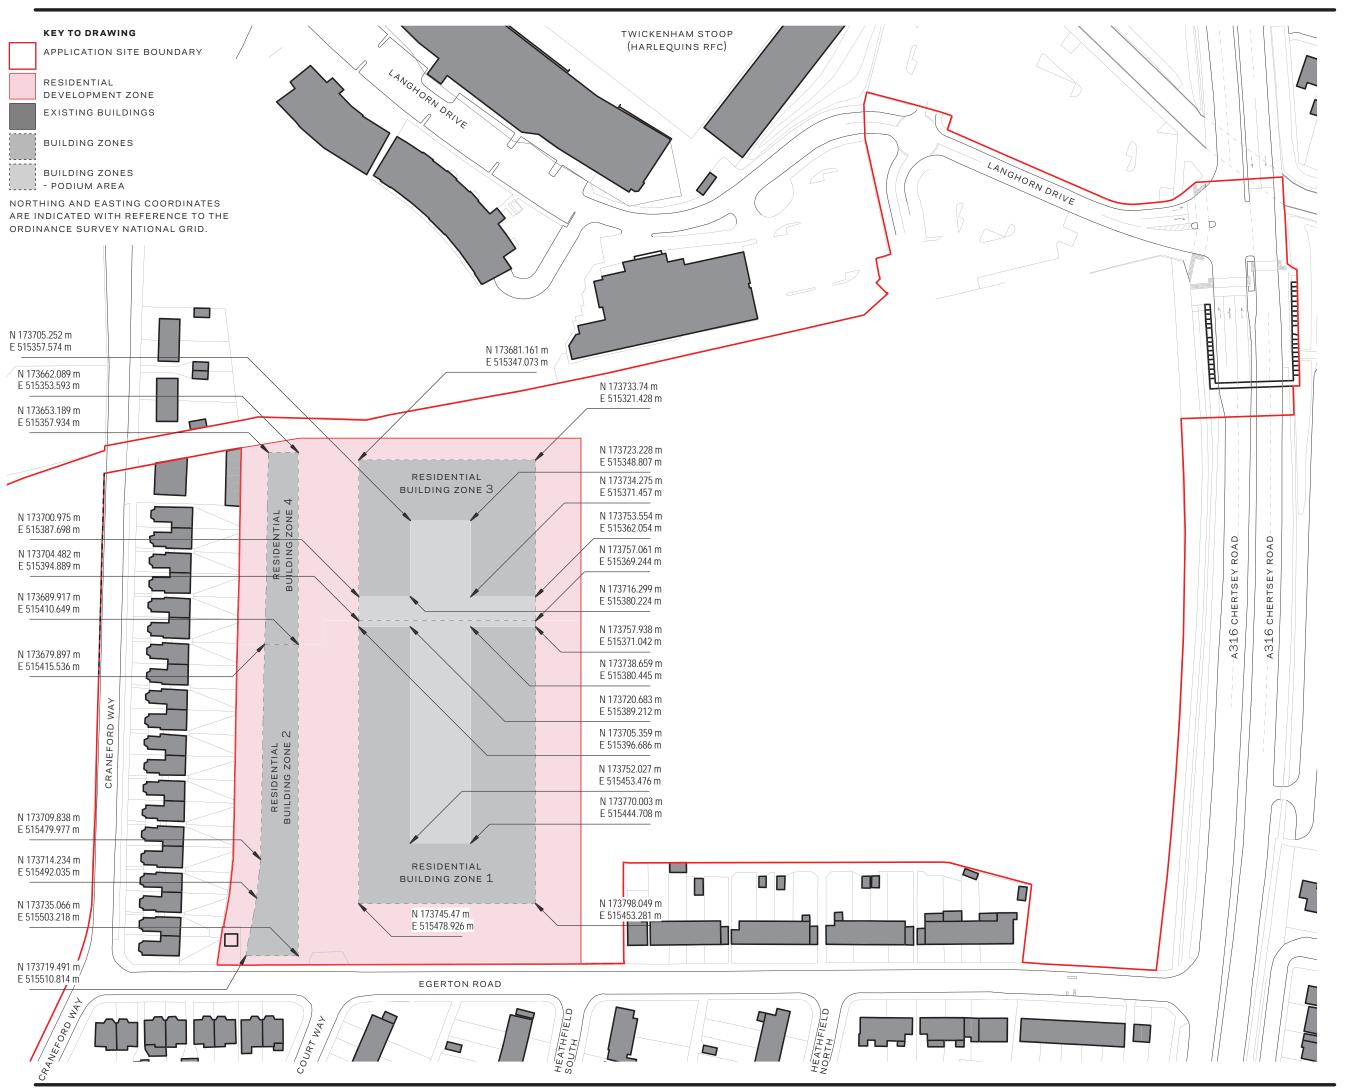

Project

REEC Richmond Education & **Enterprise Campus**

Prepared for

Richmond-upon-Thames College

Client Location

Richmond upon Thames College | Egerton Road | Twickenham | Middlesex | TW2 7SJ



Qube, 90 Whitfield Street London, W1T 4EZ, UK t +44 (0) 20 7636 2006 f +44 (0) 20 7636 1987

All reproduction & intellectual property rights reserved © 2014

FUSION PM

9 Springfield Lyons Approach, Chelmsford, Essex, CM2 5LB

VALIDUS LM

Project Management 90 Long Acre, Covent Garden, London WC2E 9RZ

CASCADE CONSULTING

Environmental Consultants
The Courtyard, Ladycross Business Park,
Hollow Lane, Dormansland, Surrey RH7 6PB

CGMS CONSULTING

Planning Consultants 140 London Wall, London EC2 5DN



No.	Description	Date
-	OPA SUBMISSION	2015.06.15


Drawn by: 1:1250 @ A3 Scale: Project No: 12.33036

Sheet Title:

Residential Development Zone Building Zones Parameter Plan 1

Original drawing is A3. Do not scale this drawing.

B MAXIMUM GROSS EXTERNAL AREA OF MAX. LENGTH MAX. LENGTH LENGTH BUILDING ZONE DEFINED IN = 20 M VARIABLE = 71.5 M **DEVELOPMENT SPECIFICATION** NOTE: HEIGHT FIGURES INDICATE MAXIMUM HEIGHT TO TOP OF ROOF PARAPETS OR EAVES. = 58.5 M = 48 M REFER TO DESIGN CODE FOR RESTRICTIONS ON THE EXTENT & LOCATION OF PROJECTIONS SUCH AS ROOF PLANT, FLUES, ETC. BUILDING HEIGHT ZONE 1 W 20 HEIGHTS INDICATED AS AOD BASED ON A MAX HEIGHT 3 M TYPICAL SITE LEVEL OF 9.20M AOD. MIN HEIGHT 0 M **BUILDING HEIGHT ZONE 4** 05 MAX HEIGHT 13 M MIN HEIGHT 10 M **M ⊸**♠ **A** MAX. HEIGHT (ZONE 6) MAX. HEIGHT (ZONE 6) 25.2 M AOD (5 storeys) 25.2 M AOD (5 storeys) MAX. LENGTH = 93.5 M MAX. HEIGHT (ZONE 4) MAX. HEIGHT (ZONE 4) ⑱ MIN. LENGTH = 80 M **PLAN** 22.2 M AOD (4 storeys) 22.2 M AOD (4 storeys) MIN. HEIGHT (ZONES 4,6) MIN. HEIGHT (ZONES 4,6) 19.2 M AOD 19.2 M AOD MAX. HEIGHT (ZONE 3) MAX. HEIGHT (ZONE 3) 19.2 M AOD (3 storeys) 19.2 M AOD (3 storeys) MIN. HEIGHT (ZONE 3) MIN. HEIGHT (ZONE 3) 15.2 M AOD 15.2 M AOD GROUND LEVEL **GROUND LEVEL** 9.2 M AOD 9.2 M AOD MAX HEIGHT (ZONE 1) MAX. HEIGHT (ZONE 1) ELEVATION A-A **ELEVATION B-B** 12.2 M AOD (1 storey) 12.2 M AOD (1 storey) RESIDENTIAL BUILDING ZONE 1

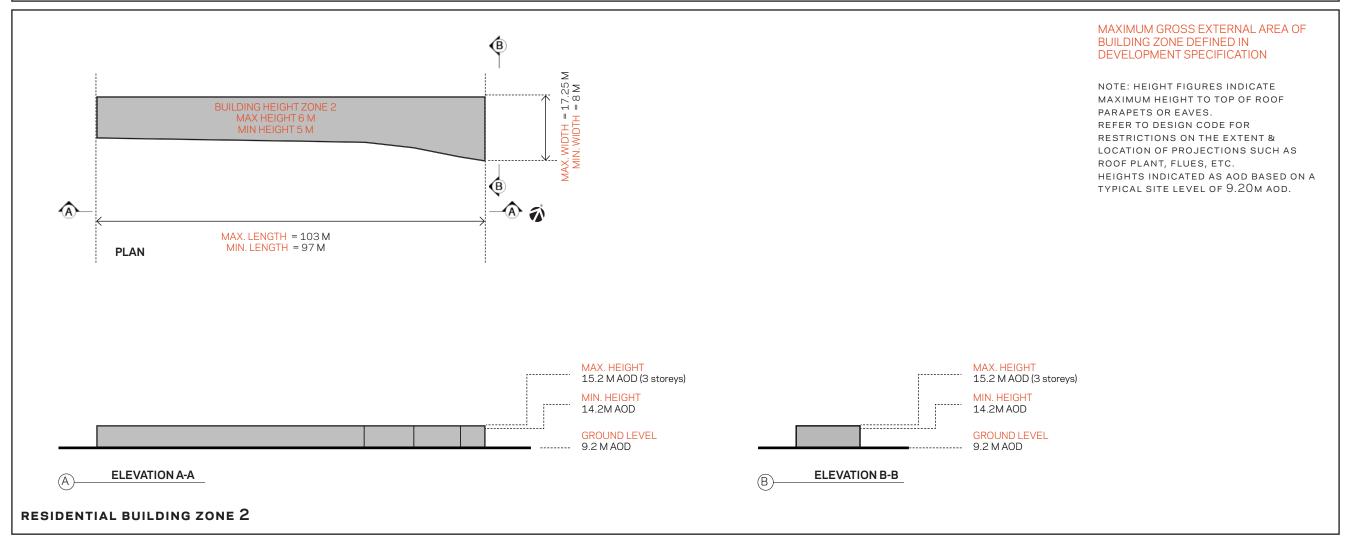

Project

REEC Richmond Education & **Enterprise Campus**

Prepared for

Richmond-upon-Thames College

Client Location

Richmond upon Thames College | Egerton Road | Twickenham | Middlesex | TW2 7SJ



Qube, 90 Whitfield Street London, W1T 4EZ, UK t +44 (0) 20 7636 2006 f +44 (0) 20 7636 1987

All reproduction & intellectual property rights reserved © 2014

FUSION PM

9 Springfield Lyons Approach, Chelmsford, Essex, CM2 5LB


VALIDUS LM

CASCADE CONSULTING

Environmental Consultants
The Courtyard, Ladycross Business Park,
Hollow Lane, Dormansland, Surrey RH7 6PB CGMS CONSULTING

Planning Consultants 140 London Wall, London EC2 5DN

KEYPLAN

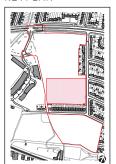

This drawing incorporates Ordnance Survey Information
© Crown copyright and database rights 2014 Ordnance
Survey 100019441

Do not scale dimensions from drawings No. Description

OPA SUBMISSION	2015.06.15


1:1000 @ A3 Scale: Project No: 12.33036

Sheet Title:

Residential Development Zone Building Zones Parameter Plan 2

Original drawing is A3. Do not scale this drawing.

Sheet Number: PL-14

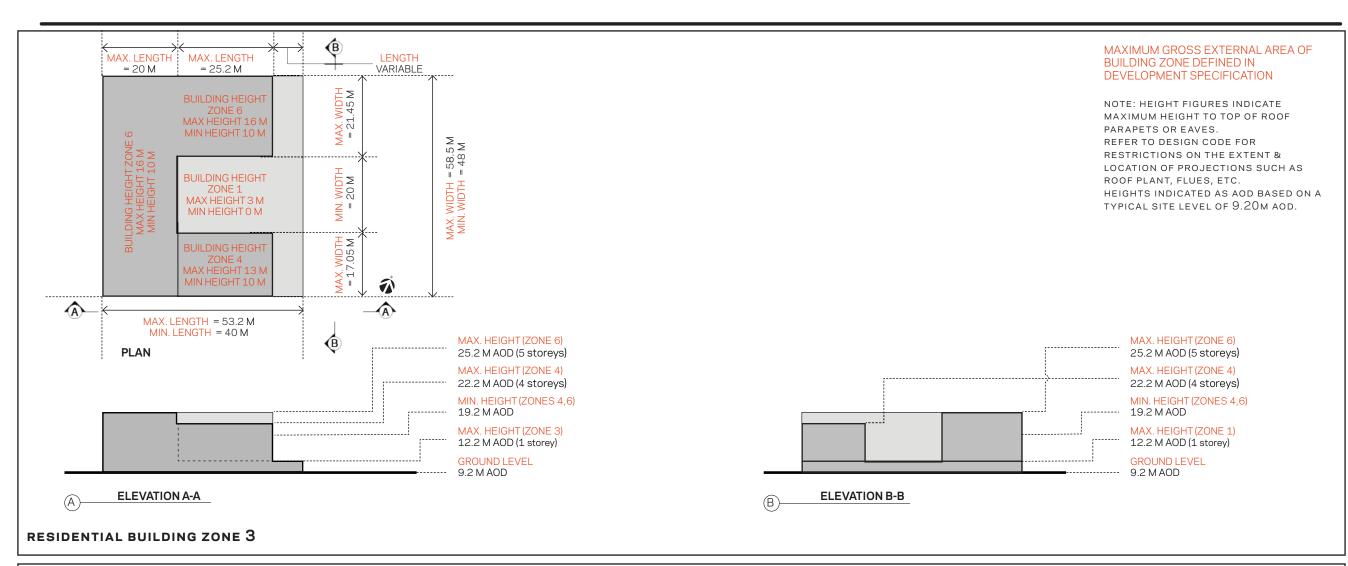

MAXIMUM GROSS EXTERNAL AREA OF **BUILDING ZONE DEFINED IN** ⑧ **DEVELOPMENT SPECIFICATION** NOTE: HEIGHT FIGURES INDICATE MAXIMUM HEIGHT TO TOP OF ROOF PARAPETS OR EAVES. REFER TO DESIGN CODE FOR RESTRICTIONS ON THE EXTENT & LOCATION OF PROJECTIONS SUCH AS ROOF PLANT, FLUES, ETC. HEIGHTS INDICATED AS AOD BASED ON A TYPICAL SITE LEVEL OF 9.20M AOD. **♠ ♠ ∕** MAX. LENGTH = 63.4 M MIN. LENGTH =57 M PLAN 15.2 M AOD (3 storeys) 15.2 M AOD (3 storeys) MIN. HEIGHT MIN. HEIGHT 14.2M AOD 14.2M AOD **GROUND LEVEL GROUND LEVEL** 9.2 M AOD 9.2 M AOD **ELEVATION B-B ELEVATION A-A** RESIDENTIAL BUILDING ZONE 4

Project

REEC Richmond Education & Enterprise Campus

Prepared for

Richmond-upon-Thames College

Client Location

Richmond upon Thames College | Egerton Road | Twickenham | Middlesex | TW2 7SJ



Qube, 90 Whitfield Street London, W1T 4EZ, UK t +44 (0) 20 7636 2006 f +44 (0) 20 7636 1987

All reproduction & intellectual property rights reserved © 2014

FUSION PM

FUSION PM

9 Springfield Lyons Approach, Chelmsford, Essex, CM2 5LB

VALIDUS LM

90 Long Acre, Covent Garden, London

CASCADE CONSULTING
Environmental Consultants
The County and Ladveross Bu

Environmental Consultants The Courtyard, Ladycross Business Park, Hollow Lane, Dormansland, Surrey RH7 6PB

CGMS CONSULTING Planning Consultants

Planning Consultants 140 London Wall, London EC2 5DN

KEYPLAN



This drawing incorporates Ordnance Survey Informat © Crown copyright and database rights 2014 Ordnan Survey 100019441

Do not scale dimensions from drawings

INO.	Description	Date
-	OPA SUBMISSION	2015.06.15

 Drawn by:
 æ
 Reviewed by: A


 Scale:
 1:1000 @ A3

 Project No:
 12.33036

Sheet Title:

Residential Development Zone Building Zones Parameter Plan 3

Original drawing is A3. Do not scale this drawing.

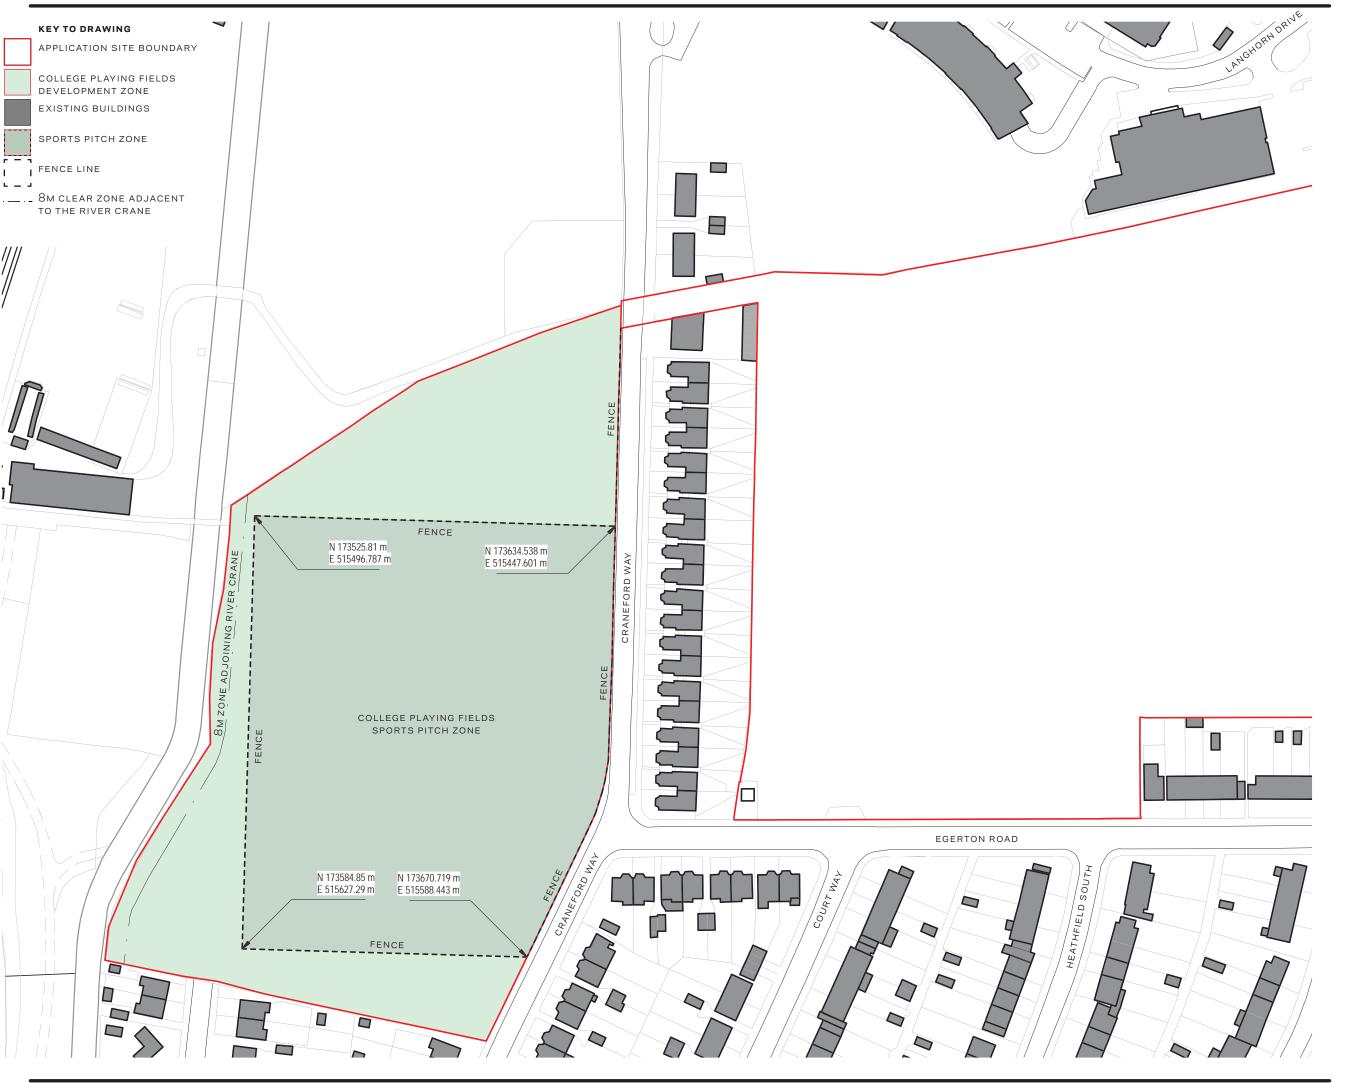

Project

REEC Richmond Education & **Enterprise Campus**

Prepared for

Richmond-upon-Thames College

Client Location

Richmond upon Thames College | Egerton Road | Twickenham | Middlesex | TW2 7SJ



HOK Qube, 90 Whitfield Street London, W1T 4EZ, UK t +44 (0) 20 7636 2006 f +44 (0) 20 7636 1987

All reproduction & intellectual property rights reserved © 2014

FUSION PM Project Manageme

9 Springfield Lyons Approach, Chelmsford, Essex, CM2 5LB

VALIDUS LM

Project Management 90 Long Acre, Covent Garden, London WC2E 9RZ

CASCADE CONSULTING

Environmental Consultants
The Courtyard, Ladycross Business Park,
Hollow Lane, Dormansland, Surrey RH7 6PB

CGMS CONSULTING

Planning Consultants 140 London Wall, London EC2 5DN





Do not scale dimensions from drawings

No.	Description	Date
-	OPA SUBMISSION	2015.06.15

1:1250 @ a3 Scale: Project No: 12.33036


Sheet Title:


College Playing Fields


Development Zone


Development Parameter Plan

Original drawing is A3. Do not scale this drawing.

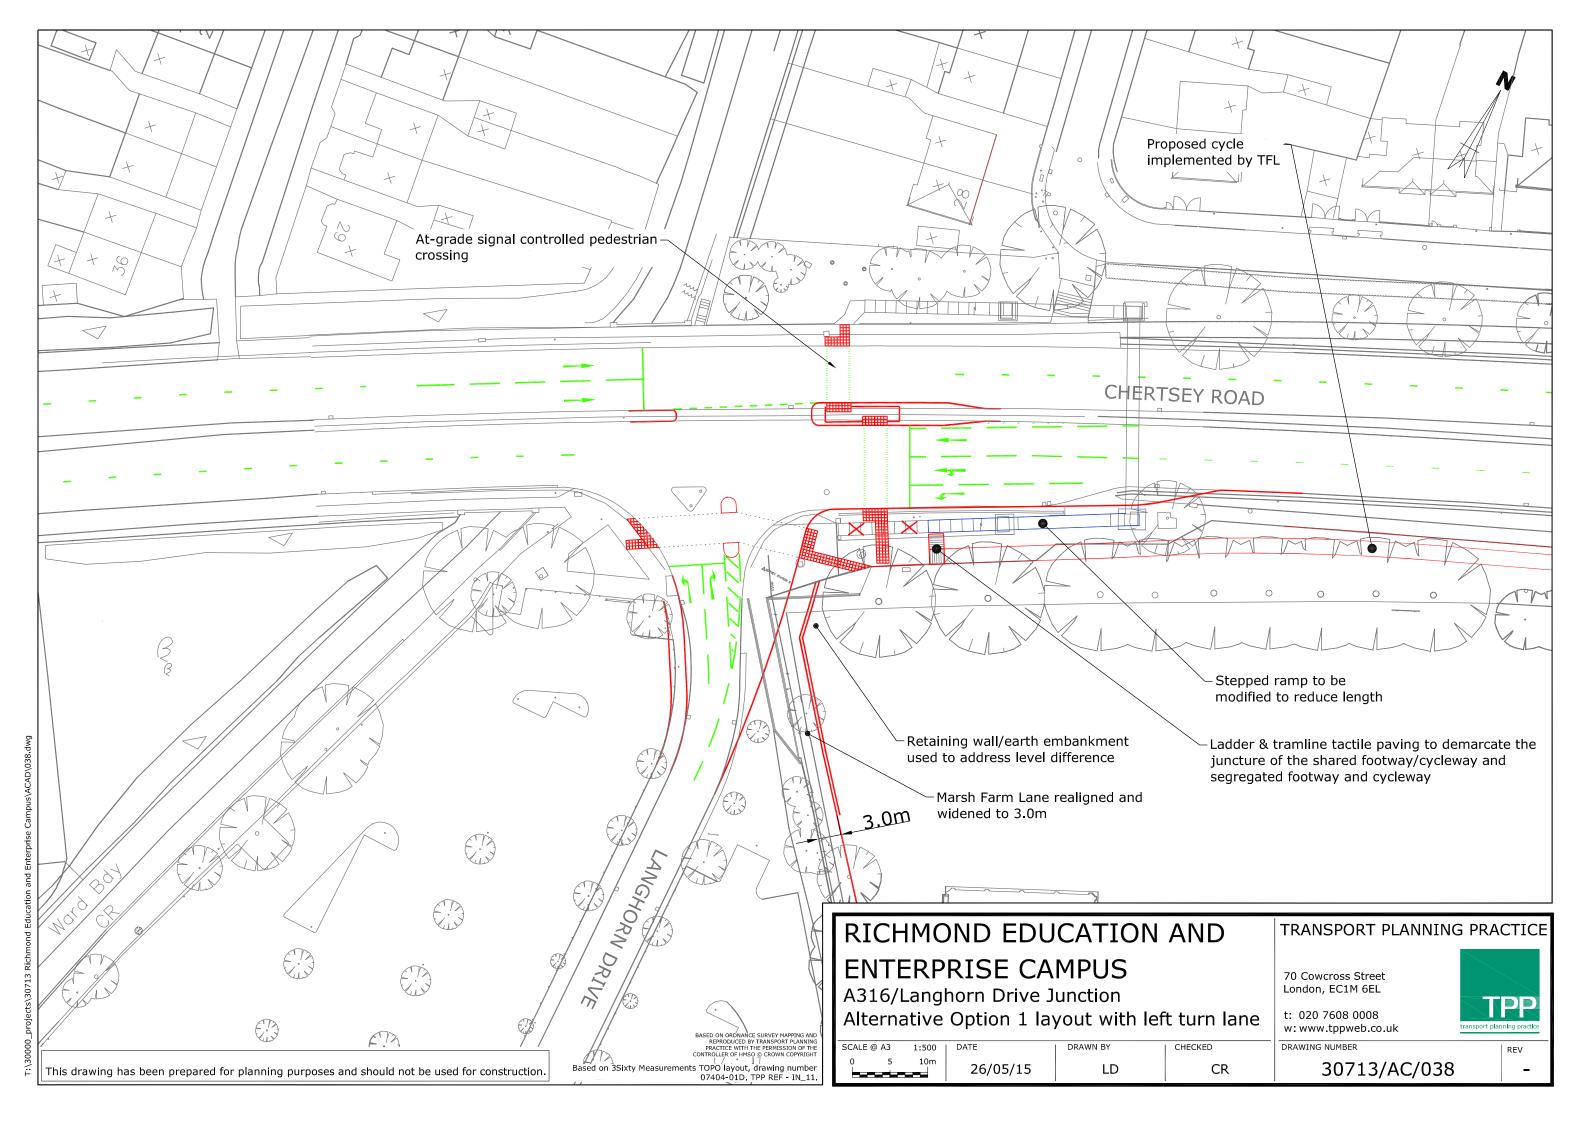

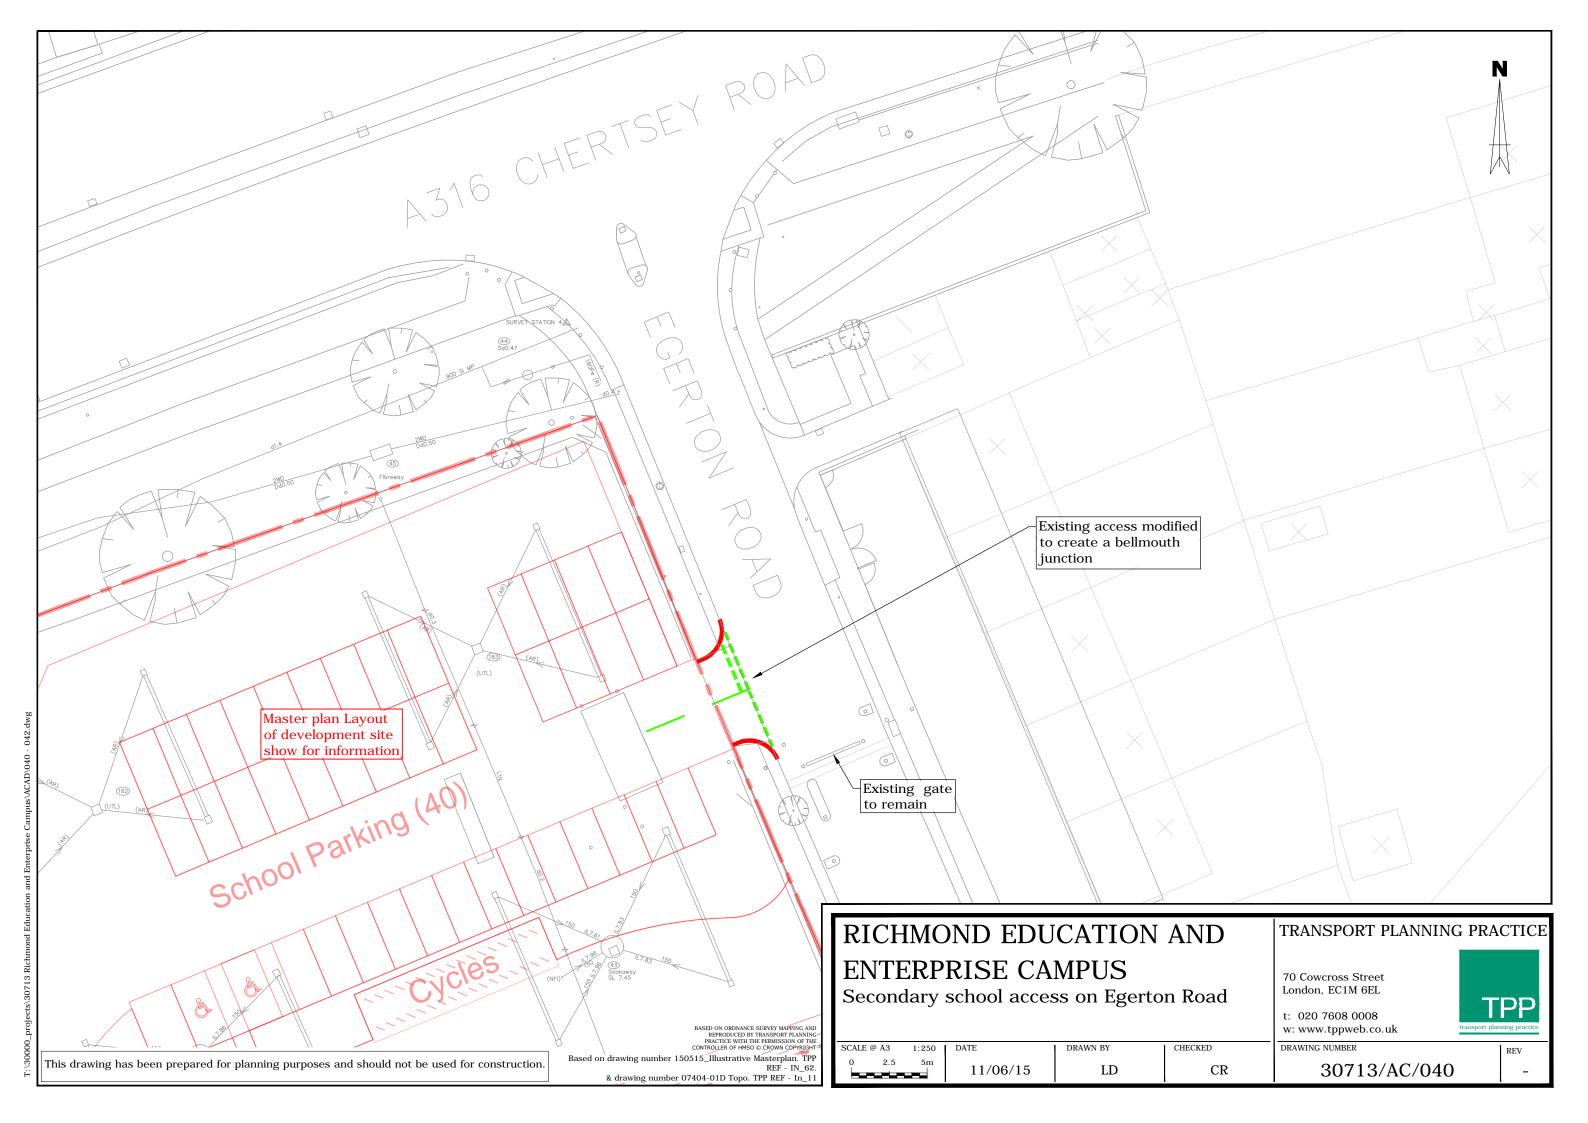

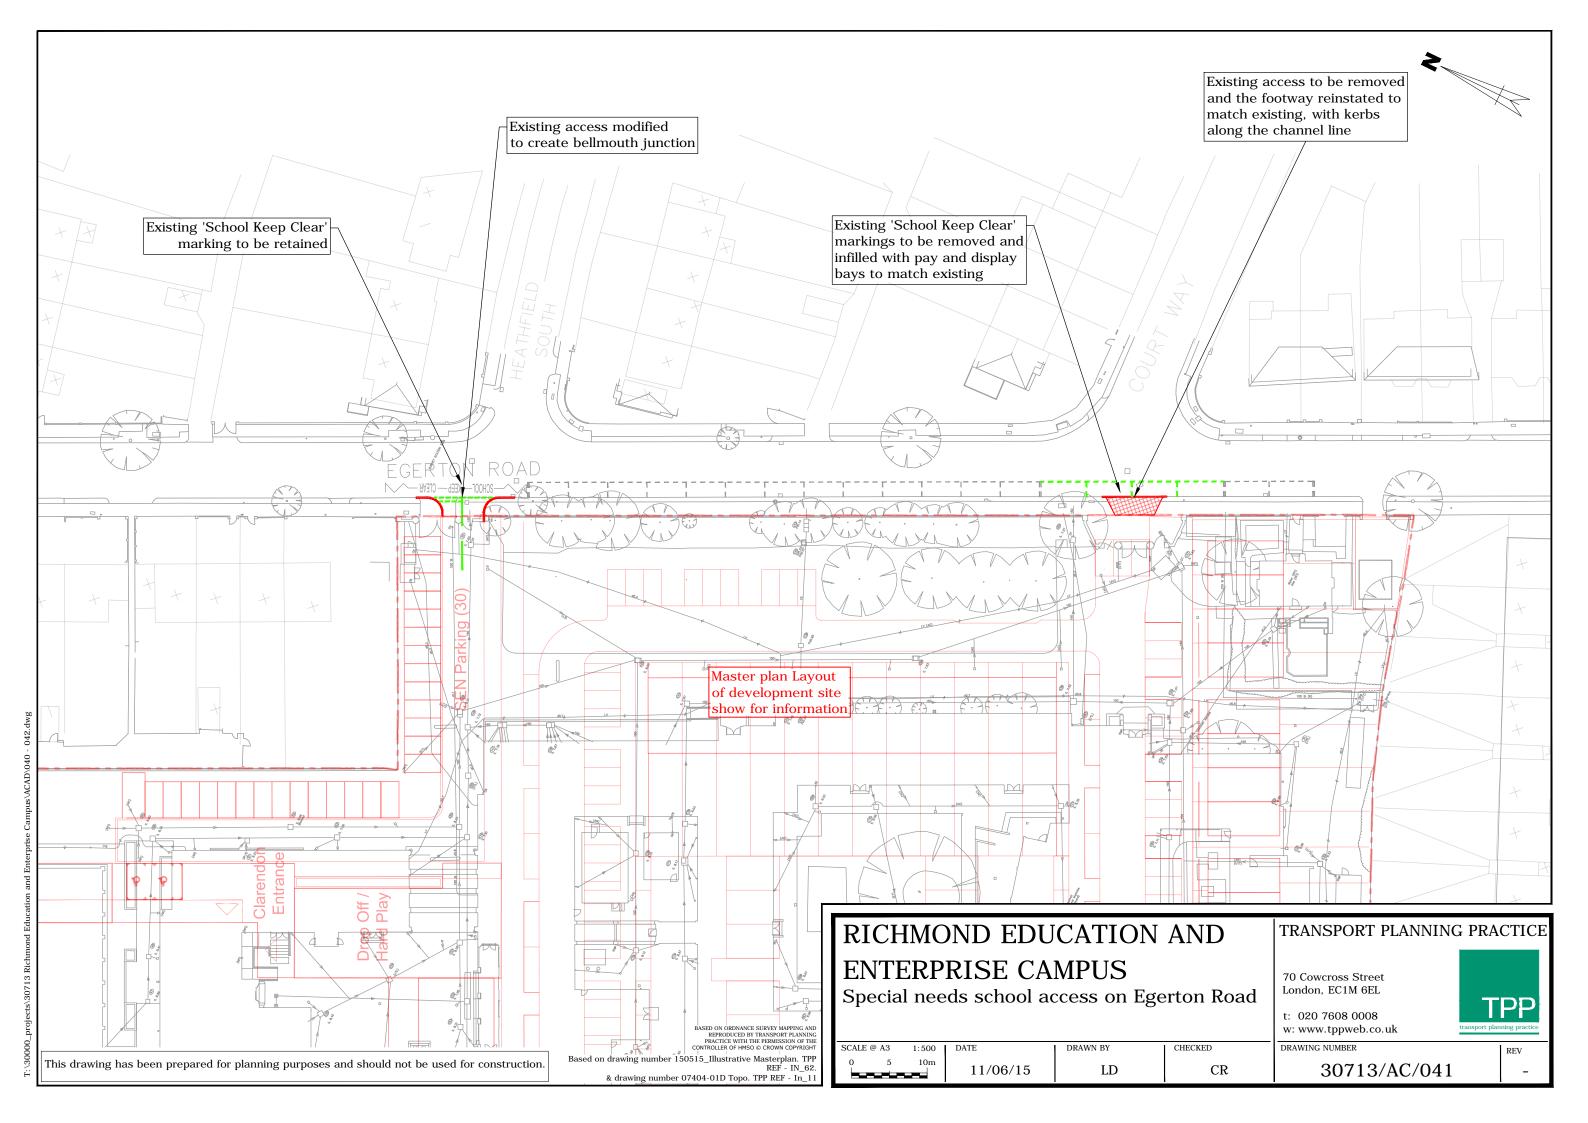

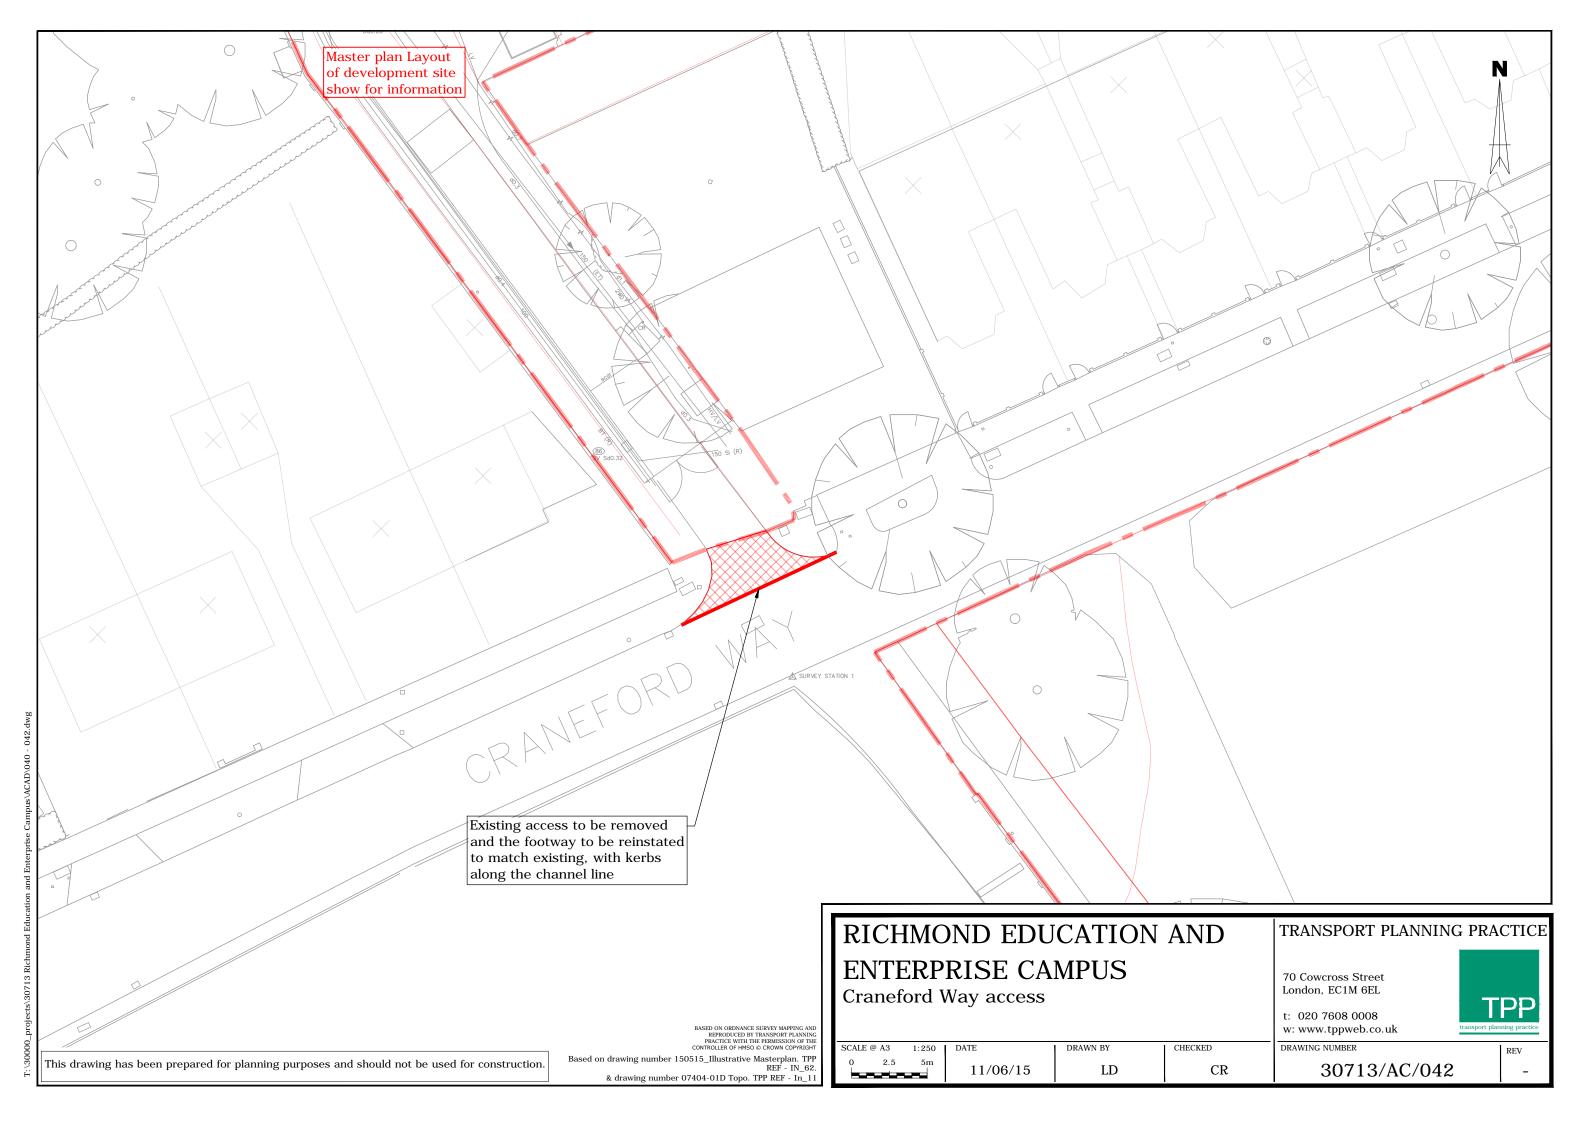

Appendix 5.2: Residential Development Phasing and Comparisons

Residential Development Phasing and Area Comparisons

	U	nits per Acre				(Calculatio	n of Nun	nber of U	nits				Maximum Car Parking	-	Car Parking Indicated	Podium					Cal	culation of I	quivalent M	inimum To	tal Area GIA	(m²)				Calculation of GEA (m²)
	Number	Number Tot of Units Num per Acre of U	mber	1 Bed 2 Person		2 Bed 4 Person	n		3 Bed 5 Person			4 Bed Person		Total	Total	Total		1 E		2 Bed 4 Person Flat	2 Bed 4 Person Maisonett	3 Bed 5 Person e Flat	3 Bed 5 Person House	4 Bed 6 Person Flat	4 Bed 6 Perso House	HOUSES Total Area	FLATS Total Net Area	FLATS Assumed Non-net		TOTAL Area Houses +	Assumed ratio of GEA to GIA
				25%	flats	2 story	45%	flats h	iomes	20% fla	ats ho	mes 1	10%				m²	╛┕	50	7	0 (83	86 1	02 9	9 1	16		159	%	Flats	105%
	4.8	38	180	45	39	42	81	8	28	36	2	16	18	217	189	189	1,329		2,250	2,73	0 3,48	86 6	588 2,8	56 19	1,8	56 8,19	5,86	6 88	0 6,74	14,944	15,691
Phase 1	3.1	34	103	30	15	26	41	0	16	16	0	16	16	127	111	127	1,329	IJL	1,500	1,05	0 2,1	58	0 1,6	32	0 1,8	56 5,64	16 2,55	38	3 2,93	8,579	9,007
Phase 2	1.7	45	77	15	24	16	40	8	12	20	2	0	2	90	78	62	-	⅃┖	750	1,68	0 1,32	28 6	588 1,2	24 19	8	0 2,55	2 3,310	5 497	7 3,81	3 6,365	6,684

Notes:

all one bed 2 storey 2 bed units are units are flats maisonettes Based on Based on LBRuT and briefing GLA provided maxima by BNPP

Based on GLA Minimum Housing Standards

Based on briefing provided by BNPP



Appendix 5.3: Residential Expected Children and External Space Calculations by Phase

Residential Expected Children and External Space Calculations by Phase

2015-06-18														
	U	nits per Ac	re				Ca	alculatio	n of Nu	umber of l	Jnits			
		Number	Total	1										
		of Units	Number	% of	1 Bed		2 Bed			3 Bed			4 Bed	
	of Acres	per Acre	of Units	total	2 Person		4 Person			5 Person			6 Person	
					25%		2 story	45%		homes	20%		homes	10%
	4.9	37	180		45	39	42	81	8	28	36	2	16	18
market			153	85%	38	33	36	69	7	24	31	1	14	15
affordable			27	15%	7	6	6		1	4	5	1	2	3
Phase 1	3.2	32	103		30	15	26	41	0	16	16	0	16	16
market			88	85%	25	13	22	35	0	14	14	0	14	14
affordable			15	15%	5	2	4	6	0	2	2	0	2	2
Phase 2	1.7	44	77		15	24	16	40	8	12	20	2	0	2
market			65	84%	13	20	14	34	7	10	17	1	0	1
affordable			12	16%	2	4	2	6	1	2	3	1	0	1

Notes:

Subtotals may not match totals due to rounding

all one bed 2 storey 2 bed units are units are flats maisonettes

Residential Expected Children and E

2015-06-18

	market	rate children/unit (market) calculated children/unit
	affordable	rate children/unit (social rented) calculated children/unit
Phase 1		
		rate children/unit (market)
	market	calculated children/unit
		rate children/unit (social rented)
	affordable	calculated children/unit
Phase 2		
		rate children/unit (market)
	market	calculated children/unit rate children/unit (social rented)
	affordable	calculated children/unit
	ајјогааые	calculated children/unit

																		Calcu	lation of Ex	pected	l Childre	n																	
		1 Be	n Flats				2 Be Person	Flats				2 Bee	louses				3 Beo	Flats				3 Beo	louses				4 Bed Person	Flat				_	louses				otal Chil		
0-4	5-10	11-15	16-18	subtotal	0-4	5-10	11-15	16-18	subtotal	0-4	5-10	11-15	16-18	subtotal	0-4	5-10	11-15	16-18	subtotal	0-4	5-10	11-15	16-18	subtotal	0-4	5-10	11-15	16-18	subtotal	0-4	5-10	11-15	16-18	subtotal	0-4	5-10	11-15	16-18	TOTAL
1.4	4 0.0	0.0	0.4	1.8	6.2	2.0	0.8	0.6	9.6	6.7	2.5	0.8	0.7	10.7	1.8	1.5	0.7	0.3	4.3	9.4	5.4	3.1	0.9	18.8	0.4	1.2	1.3	0.4	3.3	9.6	6.8	4.4	1.3	22.1	36	19	11	5	71
0.0					0.07	0.02	0.01	0.01		0.08	0.03	0.01	0.01		0.17	0.11	0.03	0.02		0.29	0.10		0.01		0.00	0.00	0.00	0.00		0.63	0.31	0.13	0.04		\Box				
0.	0.0		0.4	0.4		0.7	0.3	0.3	3.6	2.9	1.1	0.4	0.4	4.7	1.2	0.8	0.2	0.1	2.3	7.0	2.4	1.2	0.2	10.8	0.0	0.0	0.0	0.0	0.0	8.8	4.3	1.8	0.6	15.5	22	9	4	2	37
0.2	0.0	1	0.00	1.4	0.64	1	0.08		6.0	0.64	0.23	0.08	0.05	6.0	0.62	0.74	0.47	0.17 0.2		0.62 2.5		0.47 1.9	0.17	8.0	0.41	1.22	1.29	0.37	3.3	0.41	1.22	1.29 2.6	0.37	6.6	13	10	-		33
1.0			_	1.4			0.3		3.4	4.3	1.6	0.5	0.4	6.9	0.0	0.0	0.0	0.0	_			1.6	0.7	10.3	0.0	0.0	0.0	0.4	0.0		6.8	4.4	1.3	22.1	22	12	7	3	44
0.0			_	2.7	0.07			_	3.4	0.08		0.01		0.5	0.17		0.03	0.02		0.29	_		0.01	10.5	0.00	0.00	0.00	0.00	0.0	0.63		0.13					-	\vdash	
0.	0 0.0		0.4	0.4	1	1	0.1	0.1	1.4		0.7	0.2	0.2	2.9	0.0	- 1	0.0	0.0	0.0	4.1	1 1	0.7	0.1	6.3	0.0	0.0	0.0	0.0	0.0	8.8		1.8	0.6	15.5	16	7	3	1 1	26
0.2	0.0	0.0	_	***	0.64		0.08	0.05		0.64		0.08	0.05		0.62	0.74	0.47	0.17		0.62	0.74	0.47	0.17		0.41	1.22	1.29	0.37		0.41		1.29			\vdash		-	$\overline{}$	
1	0.0	0.0	0.0	1.0	1.3	0.5	0.2	0.1	2.0	2.6	0.9	0.3	0.2	4.0	0.0	0.0	0.0	0.0	0.0	1.2	1.5	0.9	0.3	4.0	0.0	0.0	0.0	0.0	0.0	0.8	2.4	2.6	0.7	6.6	7	5	4	1	18
0.4	4 0.0	0.0	0.1	0.5	4.0	1.3	0.5	0.4	6.2	2.4	0.9	0.3	0.2	3.8	1.8	1.5	0.7	0.3	4.3	4.1	2.5	1.4	0.4	8.5	0.4	1.2	1.3	0.4	3.3	0.0	0.0	0.0	0.0	0.0	13	7	4	2	27
0.0	0.0	0.0	0.01		0.07	0.02	0.01	0.01		0.08	0.03	0.01	0.01		0.17	0.11	0.03	0.02		0.29	0.10	0.05	0.01		0.00	0.00	0.00	0.00		0.63	0.31	0.13	0.04		\Box				
0.	0.0	0.0	0.1	0.1	1.4	0.4	0.2	0.2	2.2	1.1	0.4	0.1	0.1	1.8	1.2	0.8	0.2	0.1	2.3	2.9	1.0	0.5	0.1	4.5	0.0	0.0	0.0	0.0	0.0	0.0	0.0	0.0	0.0	0.0	7	3	1	1	11
0.2	0.0	0.0	0.00		0.64	0.23	0.08	0.05		0.64	0.23	0.08	0.05		0.62	0.74	0.47	0.17		0.62	0.74	0.47	0.17		0.41	1.22	1.29	0.37		0.41	1.22	1.29	0.37		\Box				
0.	4 0.0	0.0	0.0	0.4	2.6	0.9	0.3	0.2	4.0	1.3	0.5	0.2	0.1	2.0	0.6	0.7	0.5	0.2	2.0	1.2	1.5	0.9	0.3	4.0	0.4	1.2	1.3	0.4	3.3	0.0	0.0	0.0	0.0	0.0	7	5	3	1	16

Notes:

Subtotals may not match totals due to rounding

Based on GLA Shaping Neighbourhoods SPG formuæ.

calculation assumes 100% of affordable housing is social rent (as worst case scenario); any proportion of intermediate housing will reduce numbers of children and play space.

Residential Expected Children and E

2015-00-18																		
			Calculation of Minimum Childrens				hildrens	Total Shared	Calculation of Minimum Total Private Amenity Area(m²)									
					Play Spa	ace		Amenity Spaces										
								(Illustrative										
								Scheme)		2 Bed	2 Bed	3 Bed	3 Bed	4 Bed	4 Bed	FLATS	HOUSES	TOTAL
				Min 7	Total Pla	y Spac	e		1 Bed	4 Person	4 Person	5 Person	5 Person	6 Person	6 Person	Total Net	Total	Area
				(1	10m² / c	hild)			2 Person	Flat	Maisonette	Flat	House	Flat	House	Area	Area	Houses +
			0-4	5-10	11-15	16-18	TOTAL	m²	5	7	40	8	70	9	70			Flats
			356	194	111	46	706	3,382	225	273	1,680	64	1,960	18	1,120	580	4,760	5,340
		area per child	10	10		10												
	market	calculated area required	222			20			190	231	1,440	56	1,680	9	980	486	4,100	4,586
	affordable	area per child calculated area required	134	10 101		10 26			35	42	240		280		140	94	660	754
Phase 1	unoradore	carcaratea area requirea	225	120	69	28		2,508	150				1,120		1,120			
		area per child	10	10		10		,			,							-,
	market	calculated area required	156	67	29	14	265		125	91	. 880	0	980	0	980	216	2,840	3,056
		area per child	10	10	10	10												
-	affordable	calculated area required	69	53		14	176		25				140		140			479
Phase 2			131	74		19		875	75	168	640	64	840	18	0	325	1,480	1,805
		area per child	10	10	I 1	10	l						700			270	4.200	4.500
<u> </u>	market	calculated area required area per child	66 10	26 10		10	110		65	140	560	56	700	9	' "	270	1,260	1,530
	affordable	calculated area required	65	48	I 1	10	157		10	28	80	8	140		ا ا	55	220	275
	ајјогааые	calculated died required	03	40	32	12	157			20	1 80		140	1 3	1 0]]]	220	2/3

Notes:

Subtotals may not match totals due to rounding

excluding: paths, roads, private spaces; must accommodate play space provision

Balcony sizes based on GLA Minimum Housing Standards, Garden sizes for maisonettes and houses based on LBRuT DMP.

3,056

1,805

1,530

Gardens Measured, balconies assumed

Total Private Amenity Spaces (Illustrative

Scheme)



Appendix 5.4: Comparison of Existing and Illustrative External Space Types

REEC Comparison of Existing and Illustrative External Space Types

2015-06-15

			Main	site (m²)			Craneford V	Nay Site (m²)			lota	al (m²)	
Colour key	ur key Predominant Open Space Use		Phase 1e*	Phase 2d*	Illustrative	Existing	Phase 1e*	Phase 2d*	Illustrative	Existing	Phase 1e*	Phase 2d*	Illustrative
	Grass Sports Pitches		-	-		10,400	11,904	5,208	5,208	17,820	11,904	5,208	5,208
	Soft Landscaping (incl. podium)		5,892	7,742	9,809	12,383	14,898	12,350	12,350	28,550	20,790	20,092	22,159
	All Weather Sports Surfaces		1,818	3,223	3,397	920		8,439	8,439	920	1,818	11,662	11,836
	All Weather Sports Surfaces (derelict)		-	-		2,787				2,787	-	-	0
	Hard Landscaping	5,854	8,567	10,598	12,757	214		330	330	6,068	8,567	10,928	13,087
	Marsh Farm Lane (path only)	692	471	471	1,359	275	275	749	749	967	746	1,220	2,108
	Private Gardens		-	3,522	5,167					-	-	3,522	5,167
	Roads / Car Parking	10,648	8,301	8,078	12,253	98		-	-	10,746	8,301	8,078	12,253
	Subtotal Open Space		25,050	33,634	44,740	27,076	27,076	27,076	27,076	67,857	52,126	60,710	71,817
	Open Space as a % of Total Area		42%	56%	74%	100%	100%	100%	100%	78%	60%	70%	82%
	Construction Area		22,776	13,965						-	22,776	13,965	-
	Construction Area as a % of Total Area		38%	23%	0%	0%	0%	0%	0%	0%	26%	16%	0%
	Buildings		12,342	12,569	15,428	-	-	-	-	19,387	12,342	12,569	15,428
	Buildings as a % of Total Area		21%	21%	26%	0%	0%	0%	0%	22%	14%	14%	18%
	Total Area		60,168	60,168	60,168	27,076	27,076	27,076	27,076	87,244	87,244	87,244	87,245

REEC Area of Construction Site by Phase*

Phase	Construction Area (m²)
Phase 1a+1b	30,596
Phase 1c	53,692
Phase 1d+1e	22,776
Phase 2a	38,358
Phase 2b	13,806
Phase 2c+2d	13,965
Phase 3a	5,953
Phase 3b+3c	8,516

REEC Theoretical Minimum Open Space**

Development		Building Zone	Minimum Open			
Zone	Area	Footprint	Space			
College	20,144	8,828	11,317			
Tech Hub	2,336	1,395	941			
Schools	17,806	5,042	12,764			
Residential	19,882	8,035	11,847			
Main Site	60,168	23,299	36,868			
Playing Fields	27,076	-	27,076			
SubTotal	87,244	23,299	63,945			
Other Areas***	6,433	-	6,433			
Total inside						
Red Line	93,677	23,299	70,378			

^{*} Based on Phasing Drawings dated 2015.04.23

[&]quot;Minimum Space assuming 100% of building zone footprint is built; does not allow for any rooftop open space (other than any podium area)

^{***} Including areas of A316 Junction, Langhorn Drive, Harlquins Car Parking and Craneford Way All figures m² unless indicated otherwise