Mass planting: typical mixes

SHADE PLANTING



Aconitum spp.



Lunaria



Vinca difformis

SUN PLANTING







Eremurus



Saxifraga umbrosa



Aster divaricatus



Helleborus niger



Osteospermum



Armeria maritima



Tiarella spp.



Persicaria affinis







Lupinus



Crocosmia



Digitalis purpurea



Helianthemum



Blechum orientale



Polypodium









Agastache





Aster

Perovskia





Thymus vulgaris

UNDERSTORY / GROUNDCOVERS



Cyperus Involucratus



Galium Odoratum



Zantedeschia Aethiopica



Francoa Sonchifolia



Luzula Nivea



Asarum Europaeum



Dianella Tasmanica



Arum Pictum



Asplenium scolopendrium



Heuchera Cylindrica



Crinum Asiaticum



Adiantum Aleuticum



GILLESPIES



5.10 Fencing

> submission. Fencing Detail recommendations.



The school grounds will be fenced as indicated and include a full size all weather (3G) football pitch, a Multi-use Games Area (MUGA) and Habitat Area - as designated by Department for Education and Education Funding Agency's recommendations, as well as circulation and open space for children during breaks and outdoor activity times. These facilities, along with the second Play Space on the roof of the school building, and the indoor gymnasium, will be accessible to the residents of the site development and the wider community of Mortlake under a Community Agreement (a draft has been submitted with this application). This is covered in more detail elsewhere in this

Fencing to Sports Pitch and MUGA, as well as school grounds and Habitat Area is based on industry standards and is in accordance with ESFA requirements and Sport England

Lighting has been designed for the sports pitch to designated FA levels (Category 2&3) - refer to Sports Pitch Lighting Assessment 547-(010)-RP-EX-LA.

Fencing heights of 4.5m, 3m and 1.2m is in accordance with height requirements under SAPCA (Spots and Play Construction Association)Code of Practice for the Construction and Maintenance of Fencing Systems

All fence types are twin bar super rebound and black in colour. Products from manufacturers such as ZAUN and Sports & Safety Surfaces or similar approved will be used.


In respect of noise, there are a number of design solutions that will be incorporated into the design as a minimum to reduce rattle and ball impact noise, including a weld mesh with EPDM rubber inserts and fixings. If required from further subsequent detailed assessment, an acoustic grade timber fence with sufficient mass (15kg/m2) or barrier made from transparent/opaque plastic material where visual amenity is an important consideration will be incorporated. A maintenance scheme will be implemented to prevent deterioration in performance of the sports facilities that could result from damaged panels, loose brackets, worn AV bushing and squeaky gates.

Furthermore, residential building will be designed such that internal noise levels do not exceed 35 dB LAeq,16h during the daytime and 30 dB LAeq,8h & 45 dB LAmax at night from anonymous sources of noise such as road traffic. As noise levels from anonymous sources will be greater than those expected from the 3G Football Pitch and MUGA, the façade will be sufficient to reduce noise to an appropriate level.

5.11 Sports Provision

School Play facilities are considered in the application and have been measured as part of the 12 yr + age group provisions required under LBRuT and GLA Play Space requirements. Sports pitch - full size football pitch with spectator space, MUGA area (Basketball, netball, tennis court) as well as indoor sports hall and rooftop play area are provided for the school development, with total of 12120m2.

The football pitch and spectator space dimensions are using FA Guide to 3G Football Turf Pitches and designed for site specific condition.

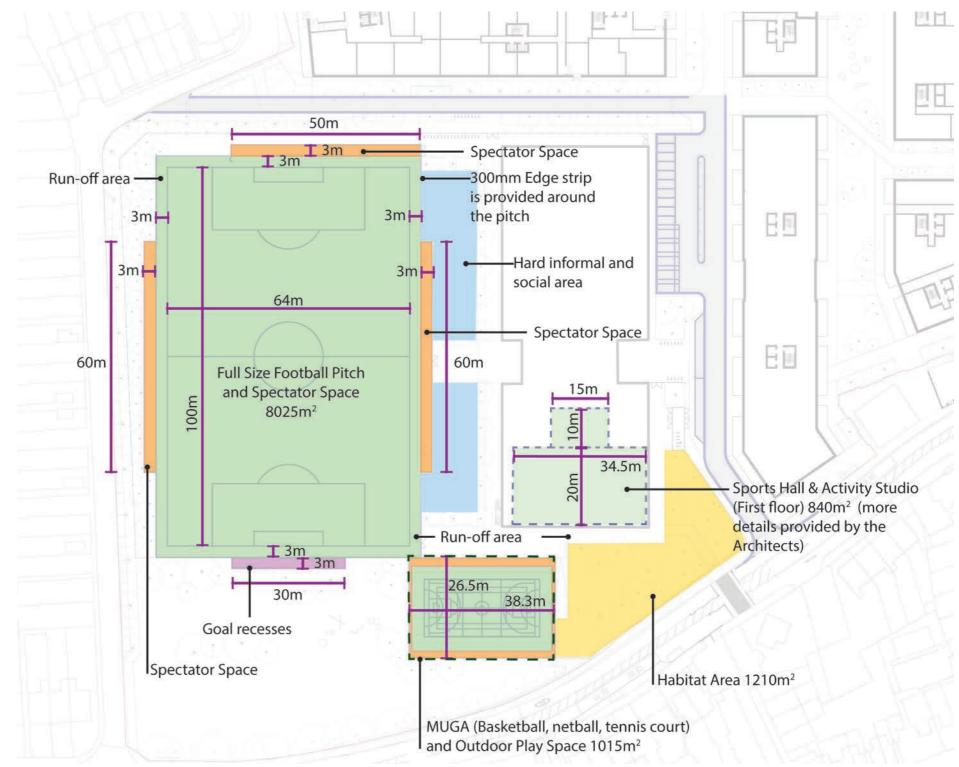


Legend








Outdoor MUGA Sports Court Dimensions

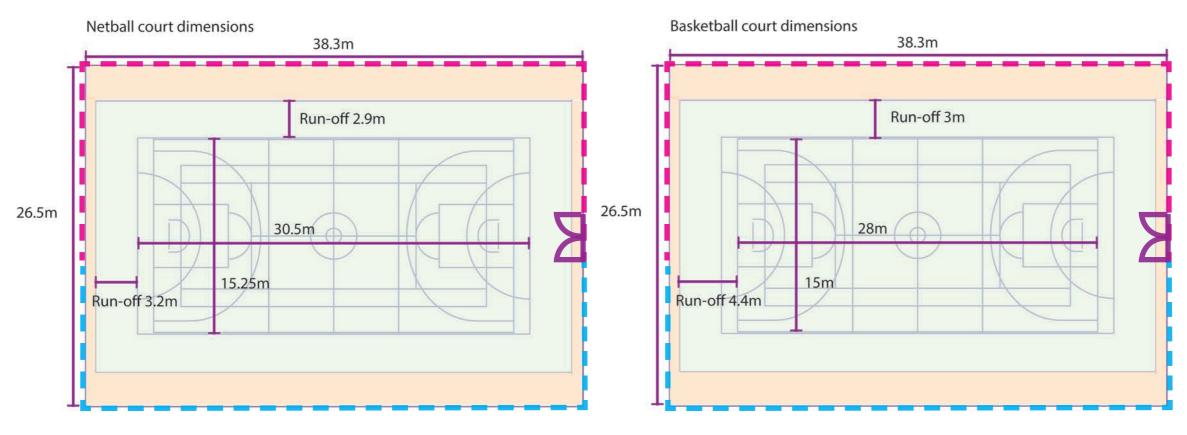

24

Tennis court dimensions

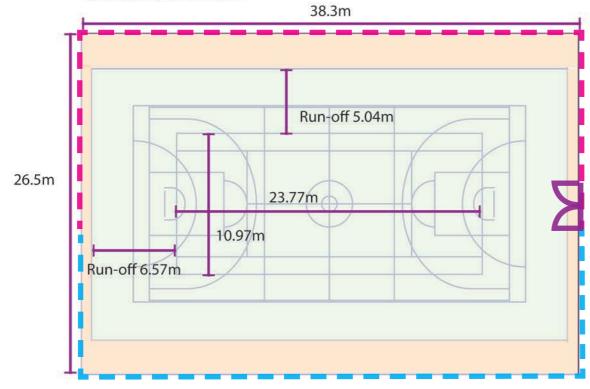


GILLESPIES

Legend


	Sports field
	Spectator area
	3m High fence
	Fence and retaining
	wall total of 3m high
\mathbf{M}	Gate



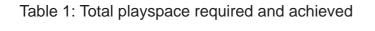


site wide including Detailed, O	Dutline areas and School
---------------------------------	--------------------------


AGE	No. of children	Play Space required GLA (Sqm)	Actual playspace provided (Excluding school)	Actual playspace provided (Including school)
0 - 5	134	1,340	1,846	1,846
5 - 11	94	940	1,612	2,553
12 - 18	53	530	626	2,508
TOTAL	281	2,810	4,084	6,907

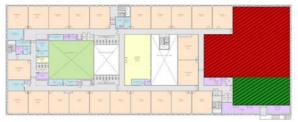

SCHOOL INDOOR MUGA / ACTIVITIES HALL

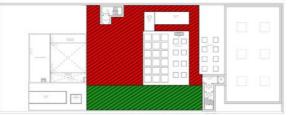

SCHOOL ROOF PLAYSPACE

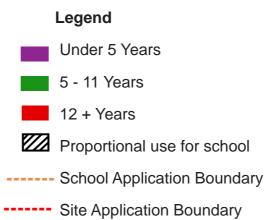

5.12 Play

Table 1 indicates targets and provision of play spaces for different age groups in and around school.

Within the calculation of the school playspace facilities (indoor and outdoor) a weighted contribution has been included in figures for 5yrs and above, in line with the intention to arrange a community use agreement with the residential development community. We have calculated these facility areas on the basis of intermittent use outside school hours (during week nights and weekends) as 2/7 of the actual space.

26

Appendix B

Appendix 5



rev	details	by	date	rev	details	by	date	
				100	Getails		uate	Notes
	Issue for Planning	RJ	02.02.2018					
D01	Issue for Planning	RJ	09.02.2018					1.0 Do not scale from drawing, use figured dir
D02	Issue for Planning	RJ	14.02.2018					1.1 All dimensions to be checked onsite
D03	Planning Substitution	RJ	11.04.2019					1.2 This drawing to be read in conjunction wit
D04	Updated for Planning	GP	26.04.2019					Gillespies drawings and specifications
D05	Updated for Planning	CL	24.09.2019					

R:\P10736-00-001 Stag Brewery Planning Application\Drawings\01 Design\CAD\P10736-00-001-100 Landscape Masterplan.dwg

LEGEND GENERAL

	Site Planning Application Boundary				
	School Planning Application Boundary				
PAVIN	G				
	Paving Type 1 Stone slabs for footpath				
	Paving Type 2 Stone paving for shared surface				
	Paving Type 5 Stone flag paving for plazas and entrances				
	Paving Type 8 Resin bound gravel				
	Paving Type 9 Artificial stone flag paving				
	Paving Type 10 School road asphalt paving with 300mm granite kerb				
	Paving Type 11 Macadam MUGA surfacing				
	Paving Type 12 3G artificial grass				
	Paving Type 13 Rubber surfacing				

STRUCTURES

-	Fence Type 1 1.2m high fence for school
	Fence Type 2 3.0m high fence for school
	Fence Type 3 4.5m high twin bar super rebound fence for school
M	Gate Type 1 Double door gate for school

FURNITURE

Cycle Stand Type 1 Sheffield cycle hoop - galvanised stee

Two Tier Cycle Shelter

Retaining Wall Retaining wall with fence

Tree Surround Type 1 Resin bound gravel

PLANTING

Short Mown Grass Existing Grass Planting Mix Hedge 1m high hedge Existing Hedge

Meadow Planting Mixed meadow planting

Existing Trees to be Retained Protected during all works

LIGHTING



- Lighting Column To lighting designer's details
- Sports Lighting Column To lighting designer's details

Sports Lighting Column To lighting designer's details

DARTMOUTH CAPITAL

Client

Alameda House, 90-100 Sydney Street, London SW3 6NJ

P: 0207 629 0239

P: 020 7253 2929 F: 020 7253 3900 E: design london



ale from drawing, use figured
sions to be checked onsite
ing to be read in conjunction v
rings and specifications

R:\P10736-00-001 Stag Brewery Planning Application\Drawings\01 Design\CAD\P10736-00-001-100 Landscape Masterplan.dwg


	Site Planning Application Boundary School Planning Application Boundary
PAVING	
	Paving Type 1 Stone slabs for footpath
	Paving Type 2 Stone paving for shared surface
	Paving Type 5 Stone flag paving for plazas and entrances
	Paving Type 8 Resin bound gravel
	Paving Type 9 Artificial stone flag paving
	Paving Type 10 School road asphalt paving with 300mm granite kerb
	Paving Type 11 Macadam MUGA surfacing Colour dark green
	Paving Type 12 3G artificial grass
	Paving Type 13 Rubber surfacing
	Paving Type 14 Macadam surfacing Colour light green

	Fence Type 1 1.2m high fence for school
	Fence Type 2 3.0m high fence for school
	Fence Tvpe 3 4.5m high twin bar super rebound fence for school
M	Gate Type 1 Double door gate for school

	Seat Type 1 Concrete bench
1111	Cycle Stand Type 1 Sheffield cycle hoop - galvanised s
,,th	Two Tier Cycle Shelte
	Retaining Wall Retaining wall with fence
	Tree Surround Type 1 Resin bound gravel

	Short Mown Grass
	Planting Mix Mixed perennial and evergreen planting
	Hedge Type 1 1.5m high hedge
	Hedge Type 2 1m high hedge
	Existing Hedge
	Meadow Planting Mixed meadow planting
0	Existing Trees to be Retained Protected during all works
1 a a	Proposed Trees

(1	Ļ
The set	L
1	S
-	ST

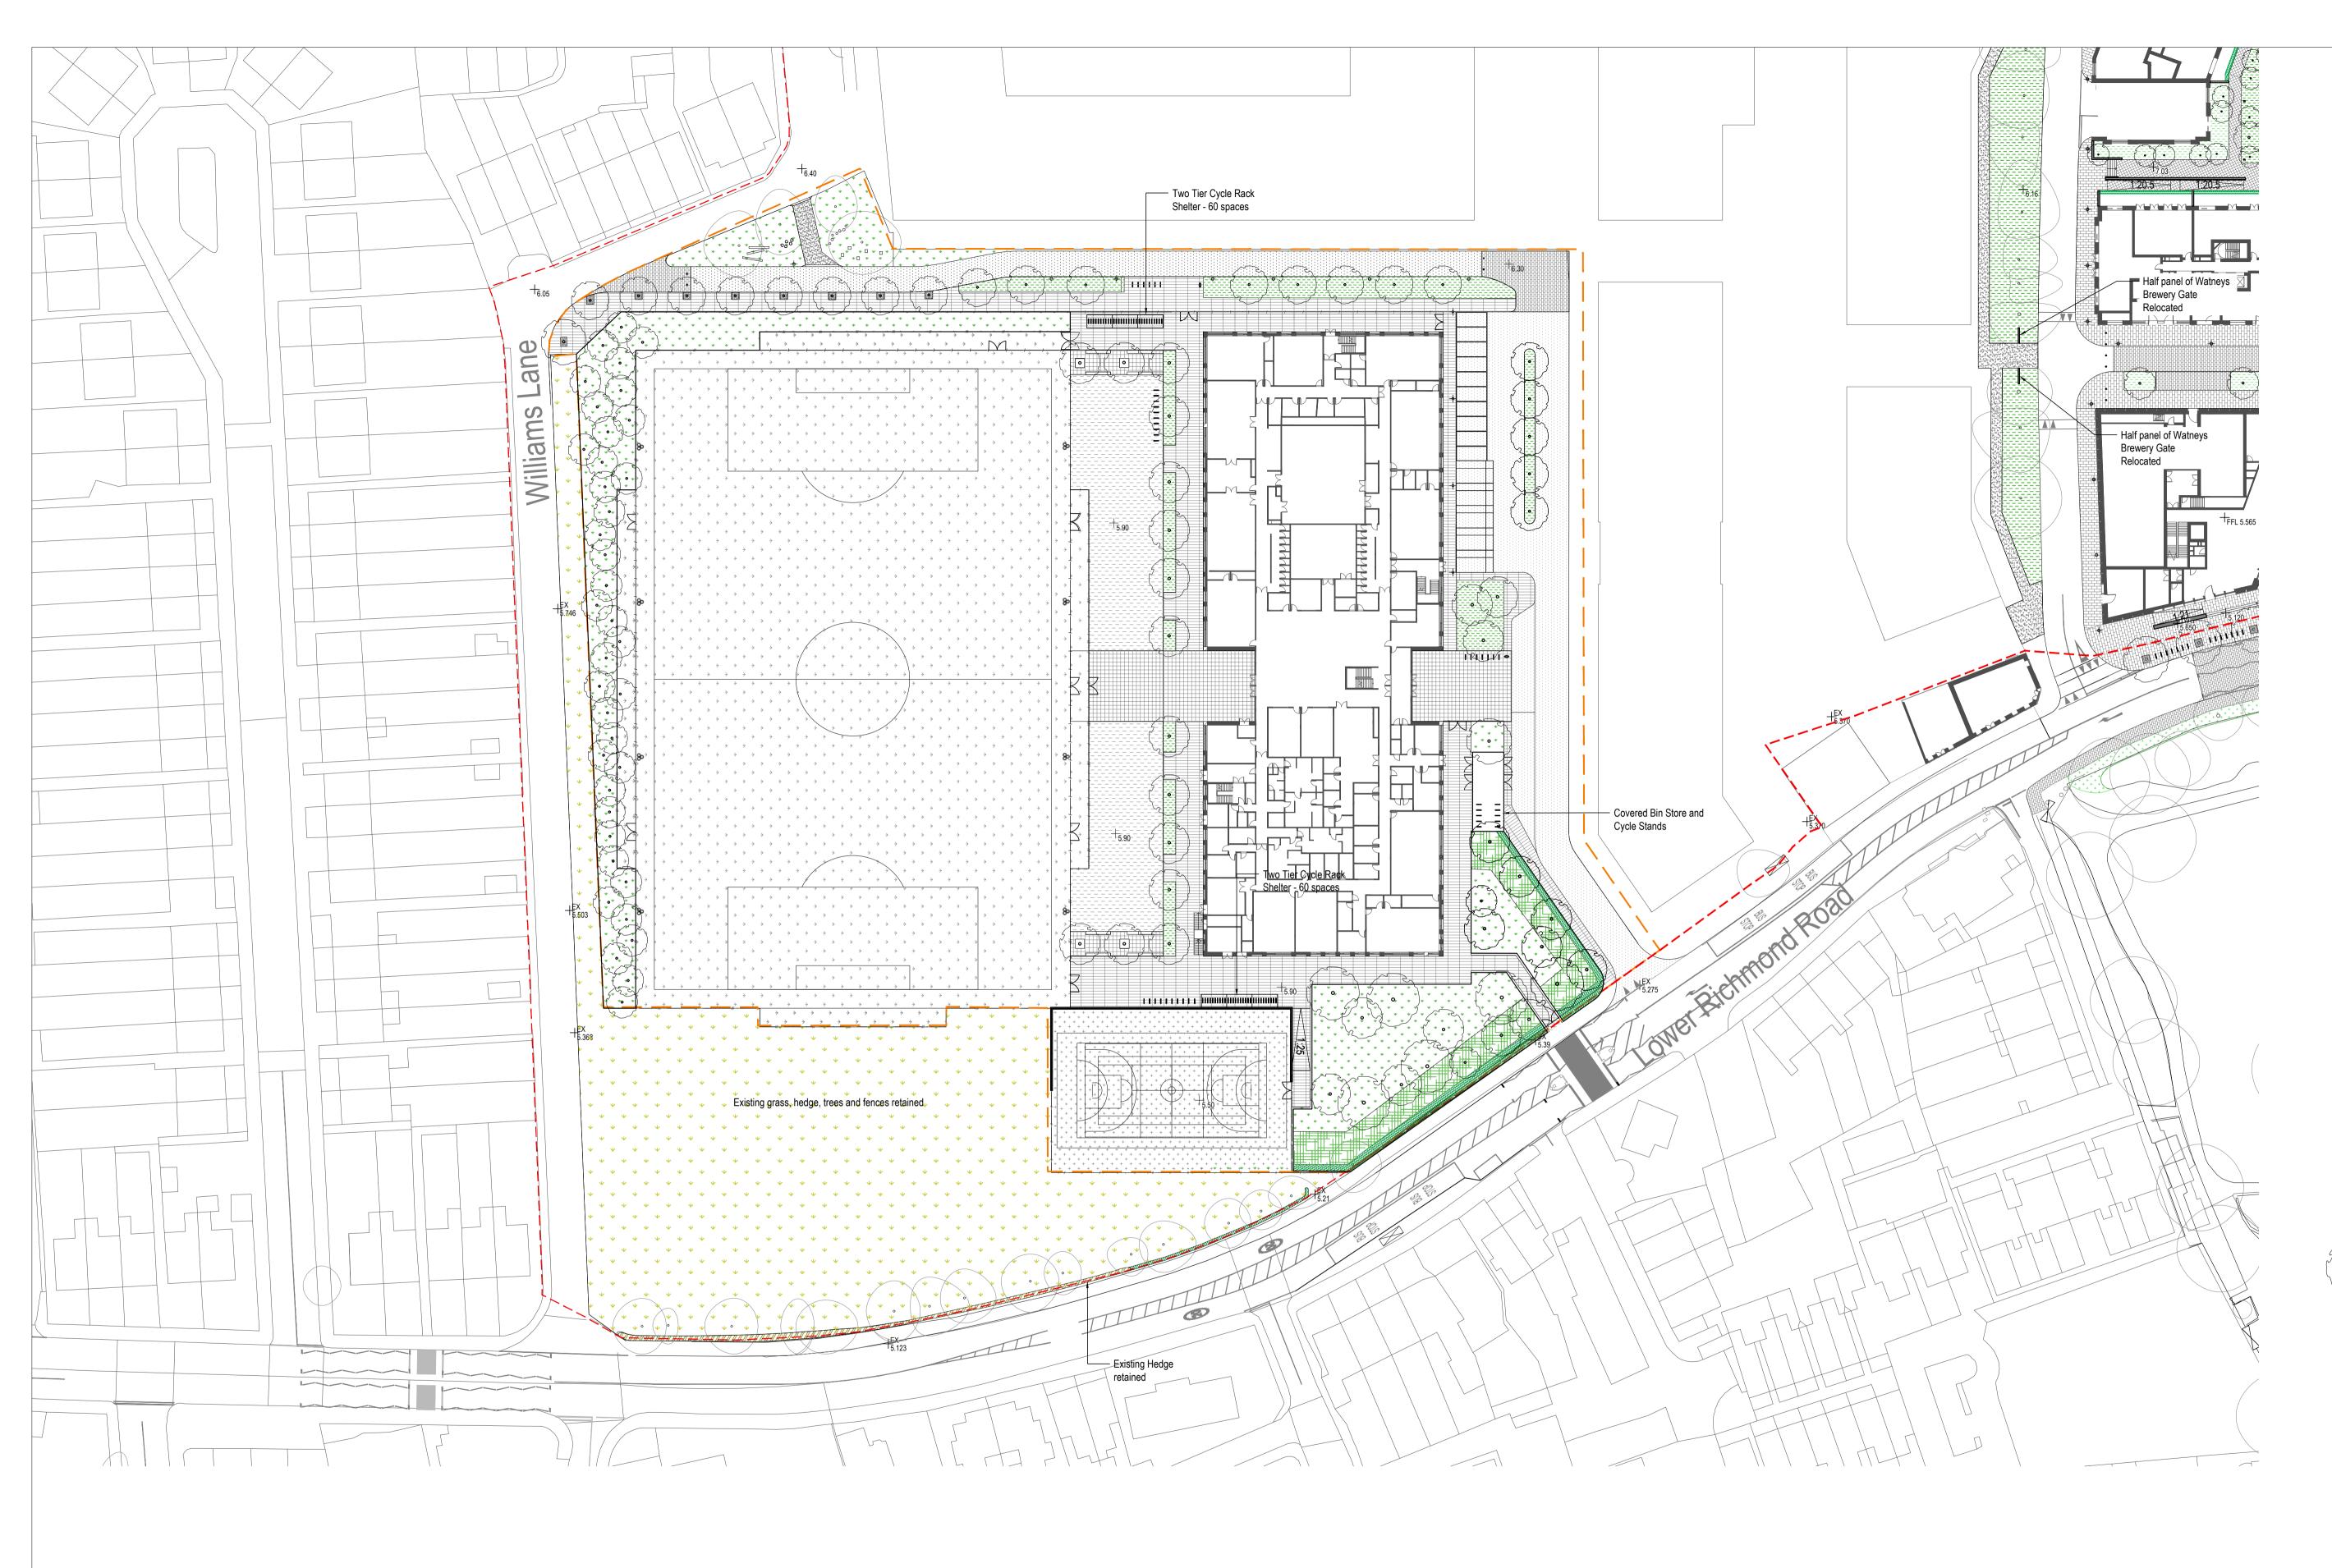

O1 SCHOOL INTERIM DESIGN - PLAN Scale 1: 500 @A1

rev	details	by	date	rev	details	by	y	date
D00	Issue for Planning Draft	RJ	16.01.2018					
D01	Issue for Information	RJ	17.01.2018					
D02	Issue for Planning	RJ	09.02.2018					
D03	Issue for Planning	RJ	13.02.2018					
D04	Updated for Planning	RJ	19.03.2019					
D05	Updated for Planning	GP	26.04.2019					
D06	Updated for Planning	CL	24.09.2019					
D07	Updated for Planning	RM	30.09.2019					


Notes


1.0 Do not scale from drawing, use figured dimensions
1.1 All dimensions to be checked onsite
1.2 This drawing to be read in conjunction with all of Gillespies drawings and specifications

\\lon-svr\projectdata\P10736-00-001 Stag Brewery Planning Application\Drawings\01 Design\CAD\P10736-00-001-132 [Interim GA].dwg

nsions only				Project title STAG BREWERY
ll other	0 5 10	25	50 m	
				Drawing title School Landscape GA Plan (Interim)

LEGE		
GENER	ALSite Planning Application	
	Boundary	
	School Planning Application Boundary	
+ ^{EX} _{00.00}	Existing Surface Level	
+_00.00	Proposed Surface Level	
+ ^{TW} _{00.00}	Top of Wall Level	
+FFL 00.00	Finished Floor Level (Internal)	
PAVING		
	Paving Type 1 Stone slabs for footpath	
	Paving Type 2 Stone paving for shared surface	
	Paving Type 5 Stone flag paving for plazas and entrances	
	Paving Type 8 Resin bound gravel	
	Paving Type 9 Artificial stone flag paving	
	Paving Type 10	
÷	School road asphalt paving with 300mm granite kerb Paving Type 11	
+ $+$ $++$ $+$	Porous Macadam MUGA surfacing	
* * * * * * *	Paving Type 12 3G artificial grass	
 	Paving Type 14 Macadam surfacing Colour light green	
STRUC	TURES	
,	Fence Type 1 1.2m high fence for school	
//	Fence Type 2 3.0m high fence for school	
	Fence Type 3 4.5m high twin bar super rebound fence for school	
	Gate Type 1 Double door gate for school	
FURNIT	IIDE	
	Seat Type 1 Concrete bench	
	Cycle Stand Type 1 Sheffield cycle hoop - galvanised steel	
	Two Tier Cycle Shelter	
	20 space per module Retaining Wall Retaining wall with fence	
	Retaining wall with fence Tree Surround Type 1	
	Resin bound gravel	
PLANTI		
* * *	Short Mown Grass	
* * * * * * * *	Existing Grass	
 	Planting Mix Mixed perennial and evergreen planting	
	Hedge Type 1 1.5m high hedge	
(7777)	Hedge Type 2 1m high hedge	
// //)	Existing Hedge Maintained	
	Meadow Planting Mixed meadow planting	
•	Existing Trees to be Retained Protected during all works	
	Proposed Trees	
	hoposed frees	
\sim		
	NG	
———	Lighting Column To lighting designer's details	
	Lighting Column To lighting designer's details	
	Sports Lighting Column To lighting designer's details	
Q	Sports Lighting Column To lighting designer's details	

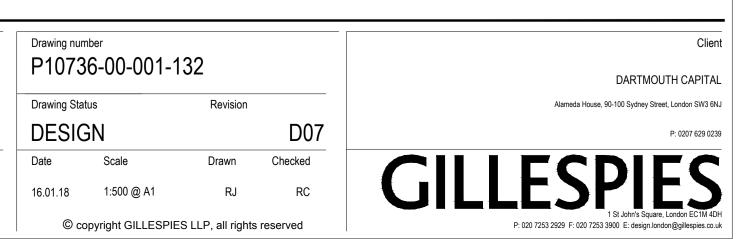

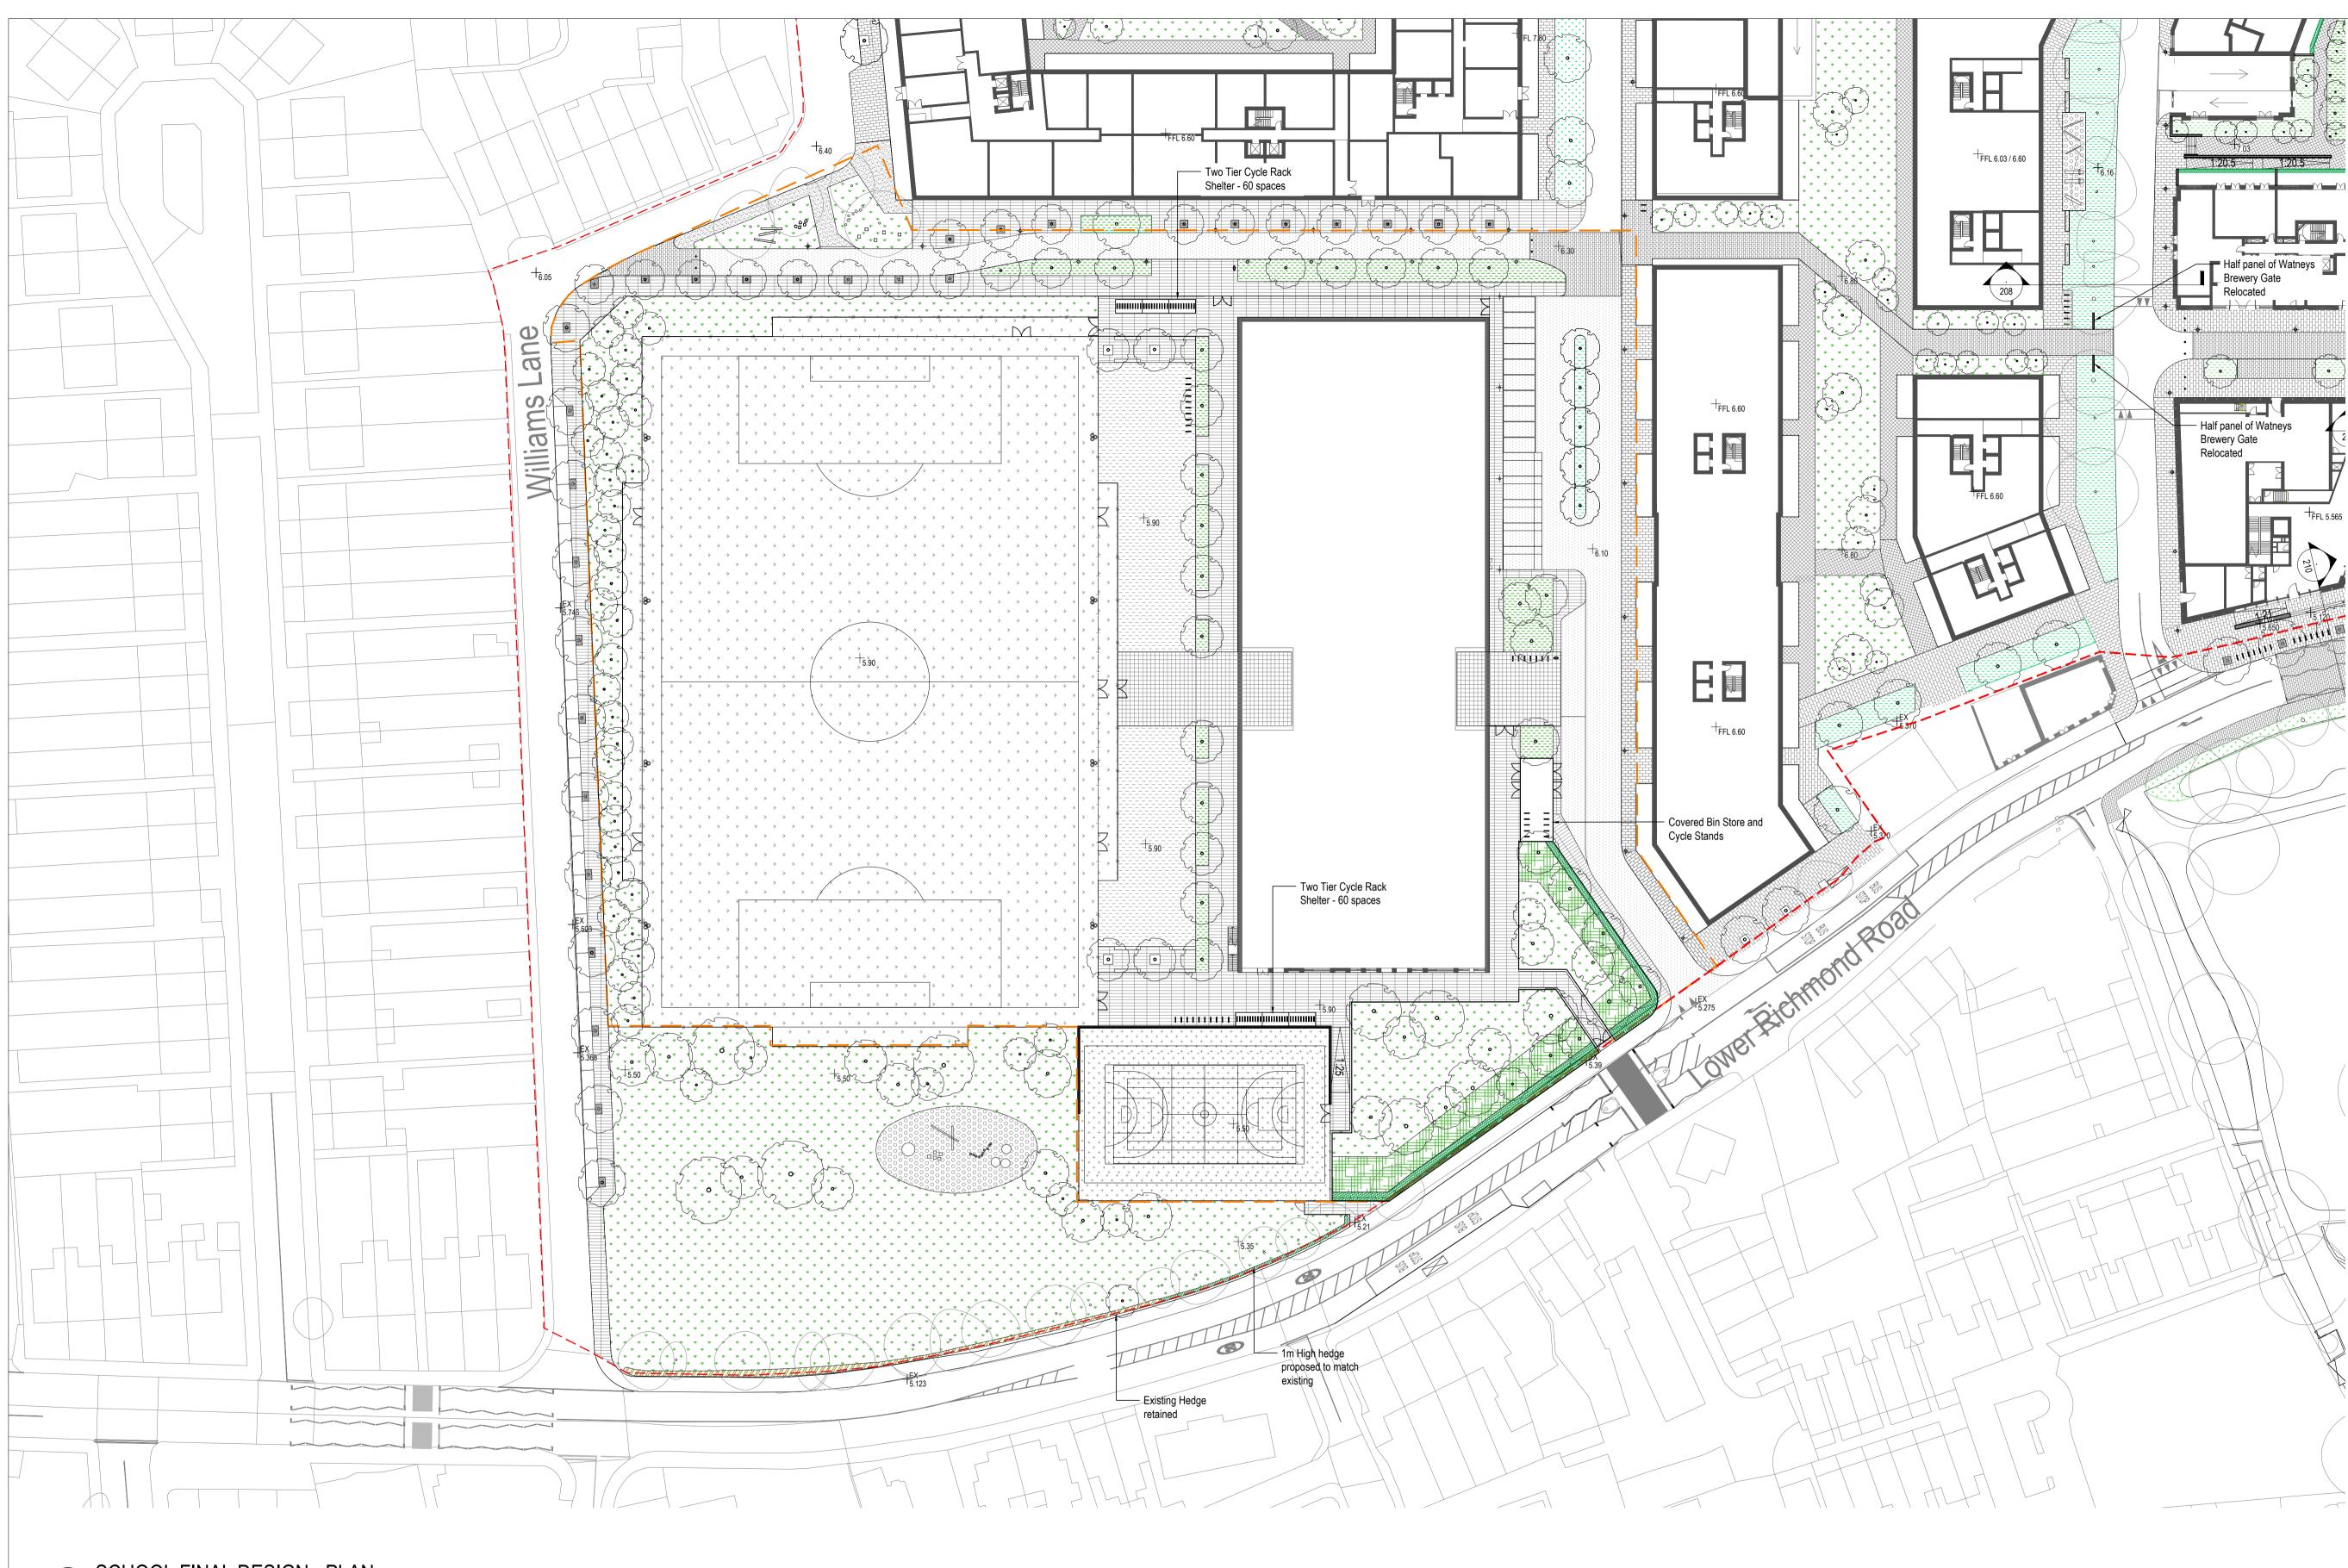

O1 SCHOOL FINAL DESIGN - PLAN Scale 1: 500 @A1

rev	details	by	date		rev	details	by	date
D00	Issue for Planning Draft	RJ	16.01.2018		D08	Planning Substitution	RM	30.09.2019
D01	Issue for Planning	RJ	02.02.2018					
D02	Issue for Planning	RJ	09.02.2018					
D03	Issue for Planning	RJ	14.02.2018					
D04	Planning Substitution	RJ	11.04.2019					
D05	Planning Substitution	GP	26.04.2019					
D06	Planning Substitution	YA	13.09.2019					
D07	Planning Substitution	CL	23.09.2019	Ī				

tes


Do not scale from drawing, use figured dimens All dimensions to be checked onsite

This drawing to be read in conjunction with all espies drawings and specifications

\\lon-svr\projectdata\P10736-00-001 Stag Brewery Planning Application\Drawings\01 Design\CAD\P10736-00-001-133 [GA].dwg


nsions only				Project title STAG BREWERY
ll other	0 5 10	25	50 m	
				Drawing title School Landscape GA Plan (Final)


LEGE GENER		
	Site Planning Application Boundary	
	School Planning Application Boundary	
+ ^{EX}	Existing Surface Level	
+ 00.00	Proposed Surface Level	
+ ^{TW} _{00.00}	Top of Wall Level	
+ ^{FFL} _{00.00}	Finished Floor Level (Internal)	
PAVING	3	
	Paving Type 1 Stone slabs for footpath	
	Paving Type 2 Stone paving for shared surface	
	Paving Type 5 Stone flag paving for plazas and entrances	
	Paving Type 8 Resin bound gravel	
	Paving Type 9 Artificial stone flag paving	
	Paving Type 10 School road asphalt paving with 300mm granite kerb	
+ + + + +	Paving Type 11 Macadam MUGA surfacing Colour dark green	
+ + + * * * *	Paving Type 12 3G artificial grass	
* * 000000 000000	Paving Type 13 Rubber surfacing for playground	
	Paving Type 14 Macadam surfacing Colour light green	
STRUC		
,	Fence Type 1 1.2m high fence for school	
	Fence Type 2 3.0m high fence for school	
	Fence Type 3 4.5m high twin bar super rebound fence for school	
	Gate Type 1 Double door gate for school	
FURNIT		
	Seat Type 1 Concrete bench	
	Cycle Stand Type 1 Sheffield cycle hoop - galvanised steel	
	Two Tier Cycle Shelter 20 space per module	
	Retaining Wall Retaining wall with fence	
	Tree Surround Type 1 Resin bound gravel	
PLANTI		
	Short Mown Grass	
* * *	Planting Mix Mixed perennial and evergreen planting	
	Hedge Type 1 1.5m high hedge	
(7777)	Hedge Type 2 1m high hedge	
// // /	Existing Hedge Maintained	
	Meadow Planting Mixed meadow planting	
•	Existing Trees to be Retained Protected during all works	
	Proposed Trees	
	}	
	NG	
	Lighting Column To lighting designer's details	
	Lighting Column To lighting designer's details	
	Sports Lighting Column To lighting designer's details	
	Sports Lighting Column To lighting designer's details	

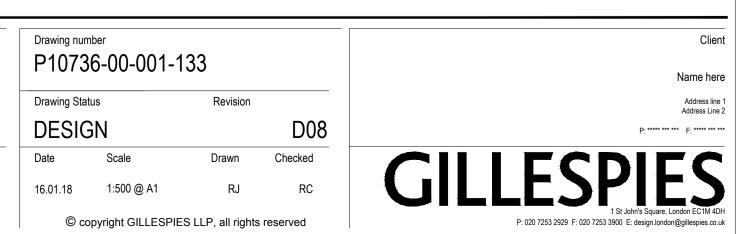

Appendix B

Appendix 6

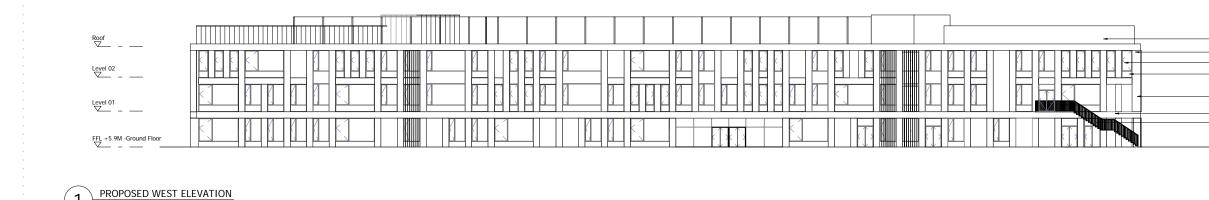

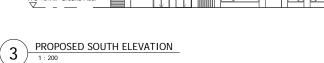

20 m


〔1〕

1:200



	PROPOSED NORTH ELEVATION
4	1 : 200


Roof	
Level 02	
Level 01	
FFL +5.9M -Ground Floor	

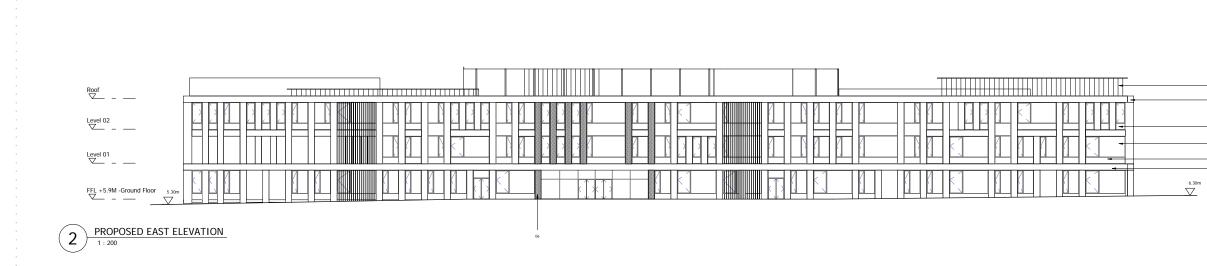

NOTES

DO NOT SCALE FROM THIS DRAWING. ALL DIMENSIONS TO BE CHECKED ON SITE. ALL OMISSIONS AND DISCREPANCIES TO BE REPORTED TO THE ARCHITECT IMMEDIATELY.

ALL RIGHTS RESERVED. THIS WORK IS COPYRIGHT AND CANNOT BE REPRODUCED OR COPIED OR MODIFIED IN ANY FORM OR BY ANY MEANS, GRAPHIC ELECTRONIC OR MECHANICAL, INCLUDING PHOTOCOPYING WITHOUT THE WRITTEN PERMISSION OF SQUIRE AND PARTINERS ARCHITECTS.

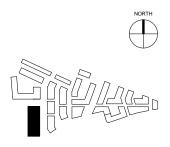

MATERIALS KEY

- 01. PPC METAL FLASHING 02. PPC METAL CLADDING 03. BRICK WALIPER 04. CLEAR GLAZING WITH PPC ALUMINIUM FRAME 05. PPC METAL SPANDREL PANEL 06. CONTRASTING BRICK TEATURE TO PIERS AROUND ENTRANCE

 02
 03
 04
05
 03
 03



SQUIRE & PARTNERS

The Department Store 248 Ferndale Road London SW9 8FR T: 020 7278 5555 F: 020 7239 0495

info@squireandpartners.com www.squireandpartners.com


Project

Stag Brewery Richmond

Drawing

Z3 SCHOOL - PROPOSED ELEVATIONS

	Drawn	Date	Scale
-	NRH	01/17/18	1:200 @ A1 1:400 @ A3
	Job Number	Drawing number	Revision
	16019	C645_Z3_E_AL_001	А

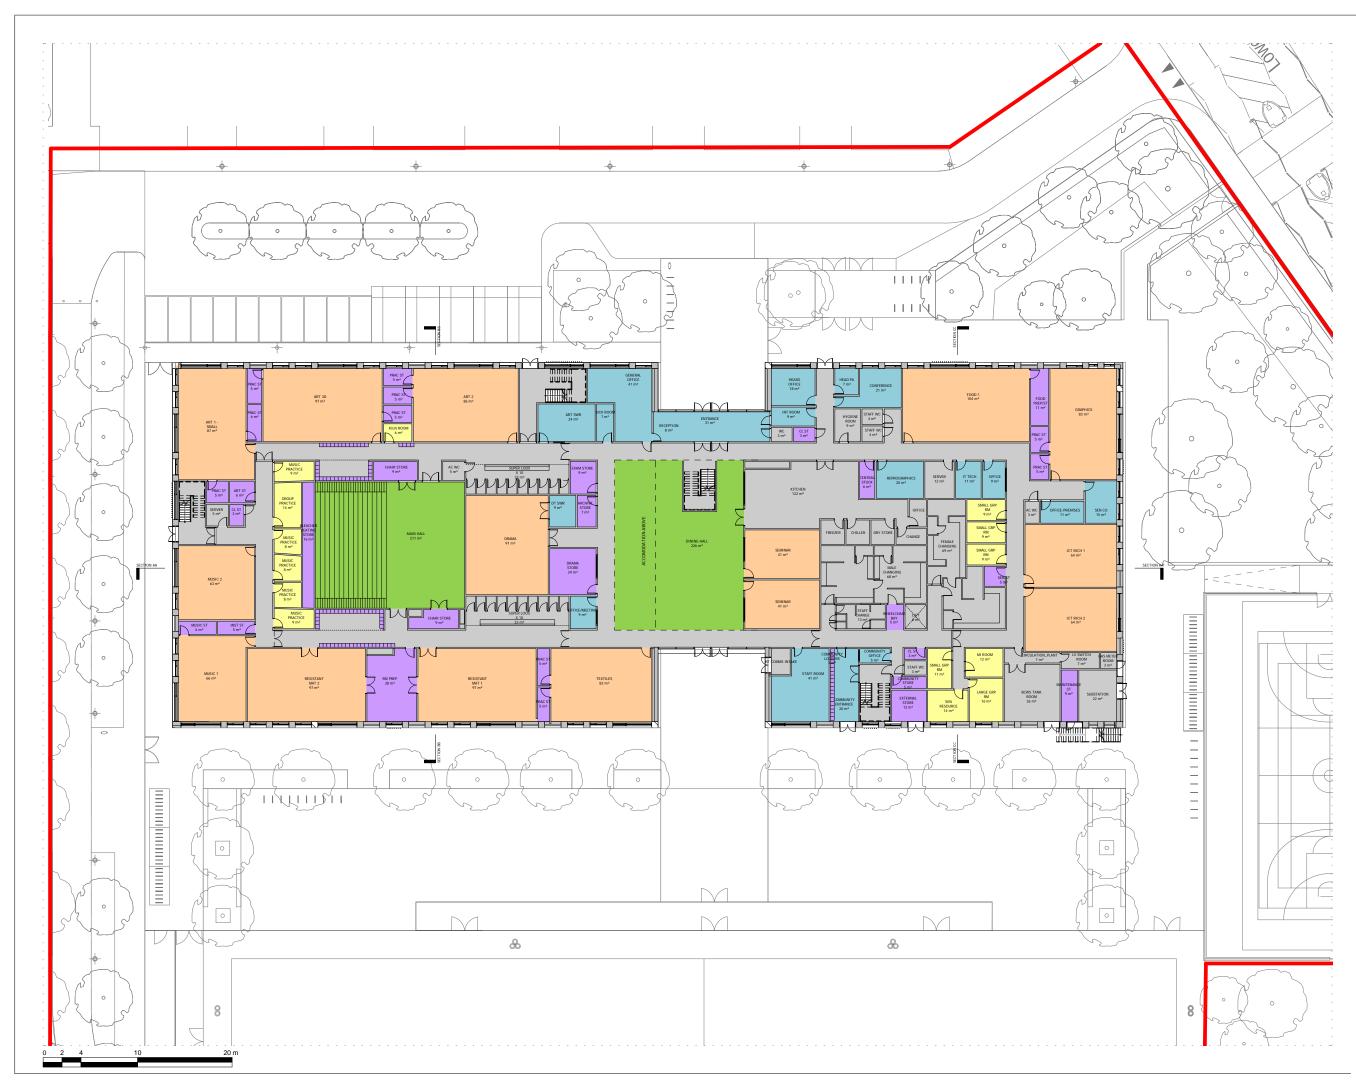

NOTES

DO NOT SCALE FROM THIS DRAWING. ALL DIMENSIONS ON SITE. ALL OMISSIONS AND DISCREPANCIES TO BE REPORTED TO THE ARCHITECT IMMEDIATELY.

ALL RIGHTS RESERVED. THIS WORK IS COPYRIGHT AND CANNOT BE REPRODUCED OR COPIED OR MODIFIED IN ANY FORM OR BY ANY MEANS, GRAPHIC ELECTRONIC OR MECHANICAL, INCLUDING PHOTOCOPYING WITHOUT THE WRITTEN PERMISSION OF SQUIRE AND PARTINERS ARCHITECTS.



SQUIRE & PARTNERS

Check Rev

Date

Revision description

The Department Store 248 Ferndale Road London SW9 8FR T: 020 7278 5555 F: 020 7239 0495

info@squireandpartners.com www.squireandpartners.com


Project

Stag Brewery Richmond

Drawing

Z3 SCHOOL - PROPOSED GROUND FLOOR PLAN


Drawn	Date	Scale	
RKL	01/17/18	1:200 @ A1 1:400 @ A3	
Job Number	Drawing number	Revision	
16019	C645_Z3_P_00_001	А	

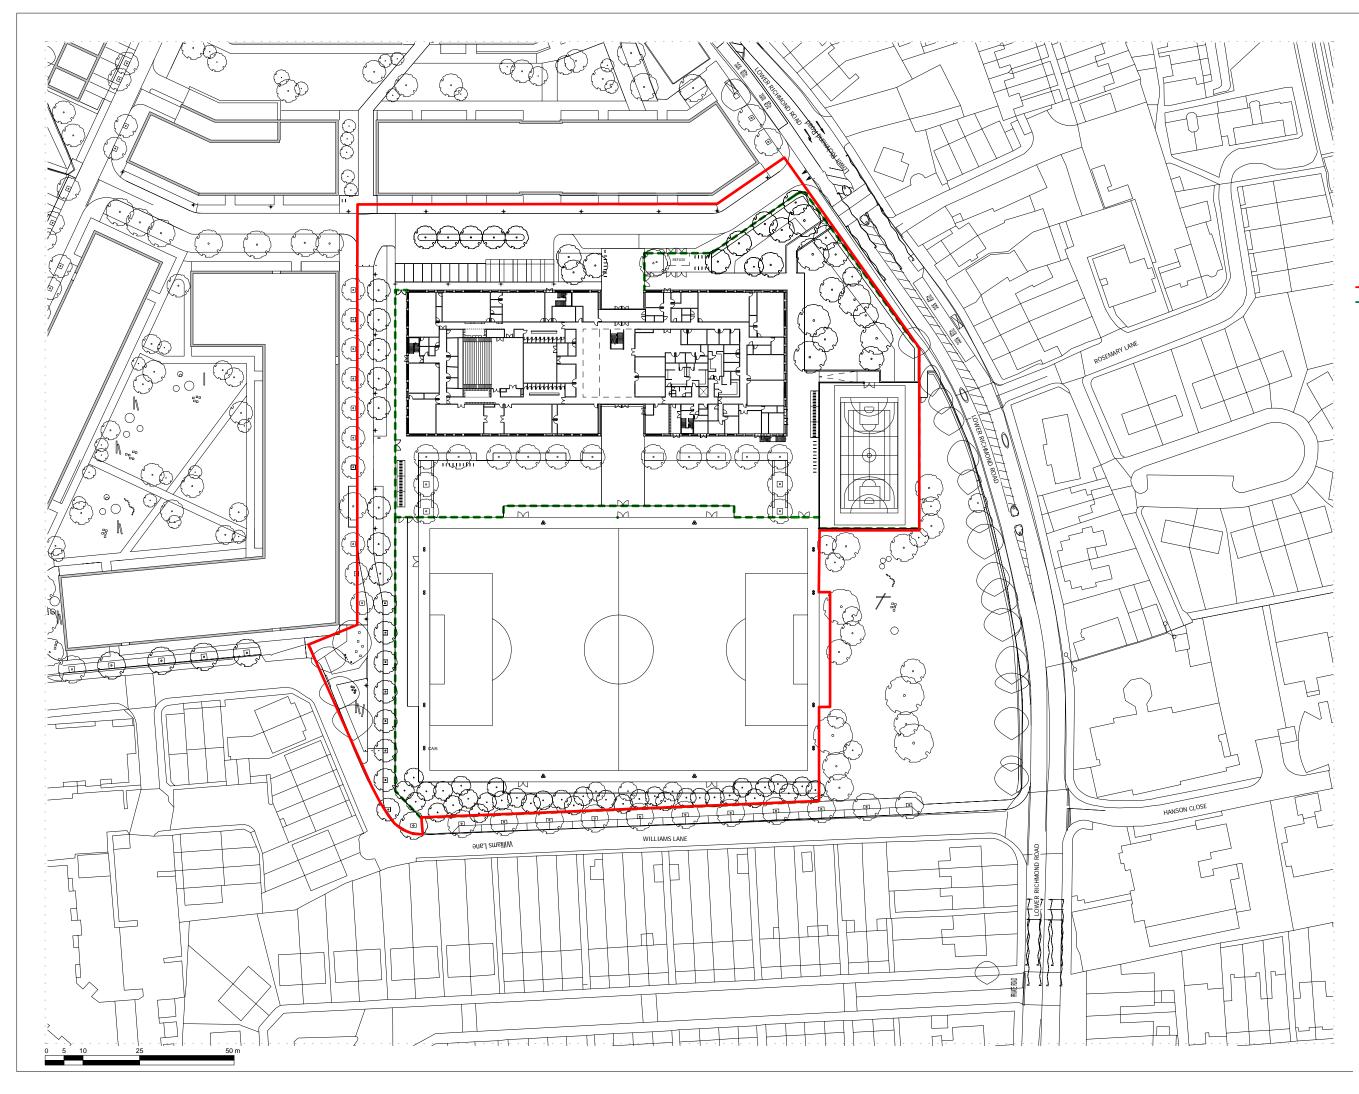

NOTES

DO NOT SCALE FROM THIS DRAWING. ALL DIMENSIONS TO BE CHECKED ON SITE. ALL OMISSIONS AND DISCREPANCIES TO BE REPORTED TO THE ARCHITECT IMMEDIATELY.

ALL RIGHTS RESERVED. THIS WORK IS COPYRIGHT AND CANNOT BE REPRODUCED OR COPIED OR MODIFIED IN ANY FORM OR BY ANY MEANS, GRAPHIC ELECTRONIC OR MECHANICAL, INCLUDING PHOTOCOPYING WITHOUT THE WRITTEN PERMISSION OF SQUIRE AND PARTNERS ARCHITECTS.

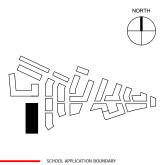

SCHOOL FENCE LINES

PLANNING SUBSTITUTION DRAWINGS 01/03/19 EmK A PLANNING APPLICATION 12/02/18 BJ -	Revision description	Date	Check	Rev

SQUIRE & PARTNERS

The Department Store 248 Ferndale Road London SW9 8FR T: 020 7278 5555 F: 020 7239 0495

info@squireandpartners.com www.squireandpartners.com


Project Stag Brewery

Richmond

Drawing

Z3 SCHOOL -PROPOSED SITE PLAN


Drawn	Date	Scale	
RKL	01/17/18	1:500 @ A1 1:1000 @ A3	
Job Number	Drawing number	Revision	
16019	C645_Z3_P_AL_001	А	

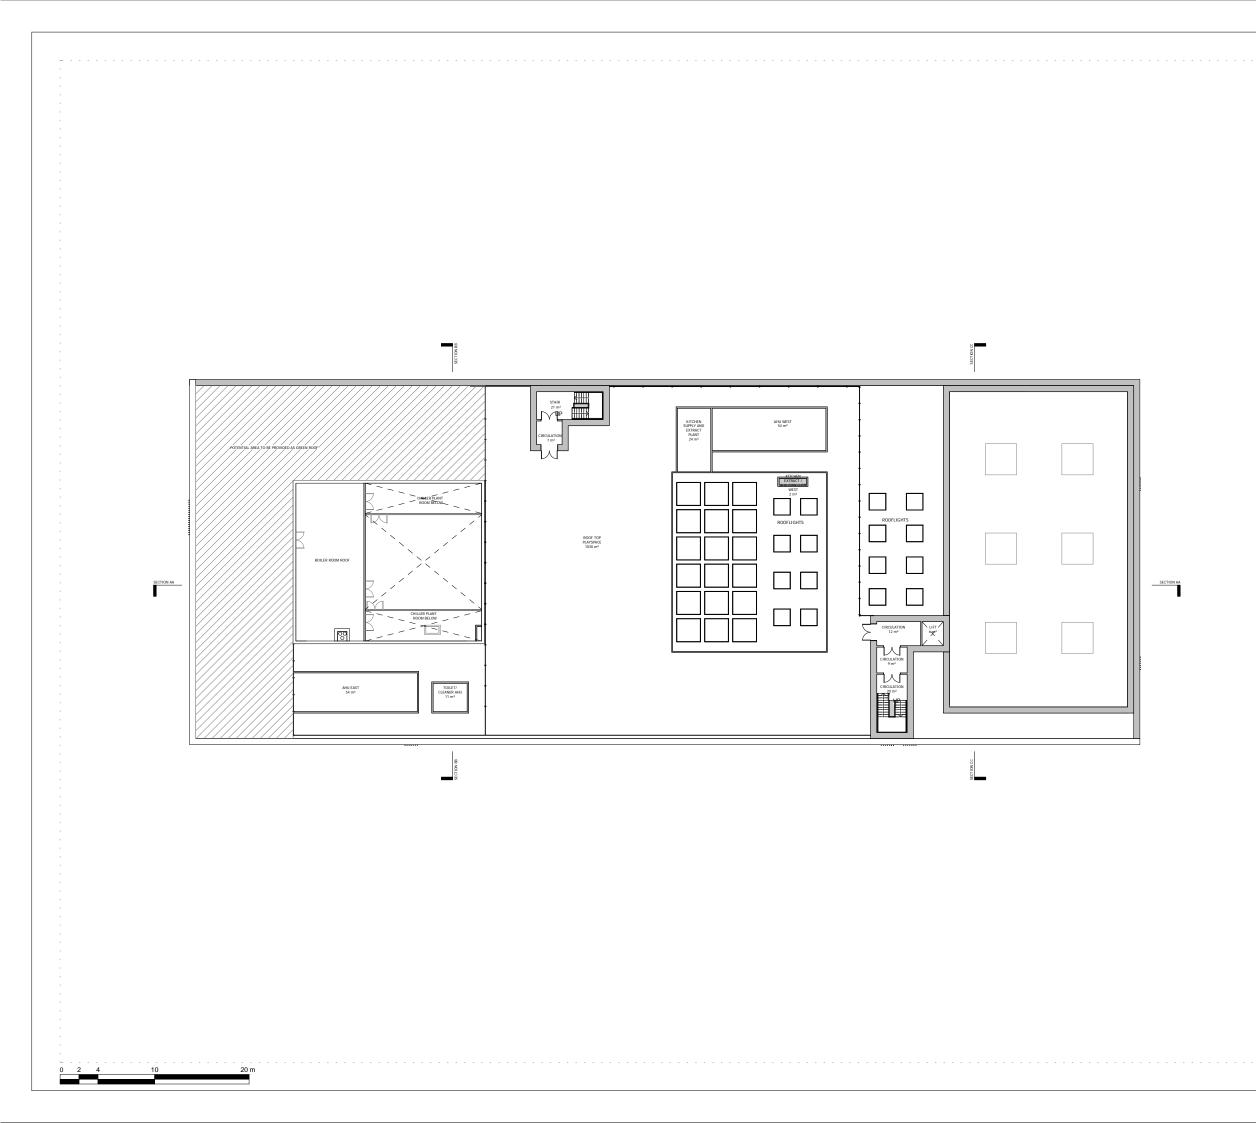

NOTES:

DO NOT SCALE FROM THIS DRAWING. ALL DIMENSIONS TO BE CHECKED ON SITE. ALL OMISSIONS AND DISCREPANCIES TO BE REPORTED TO THE ARCHITECT IMMEDIATELY.

ALL RIGHTS RESERVED. THIS WORK IS COPYRIGHT AND CANNOT BE REPRODUCED OR COPIED OR MODIFIED IN ANY FORM OR BY ANY MEANS, GRAPHIC ELECTRONIC OR MICHANICAL, INCLUDING PHOTOCOPYING WITHOUT THE WRITTEN PERMISSION OF SQUIRE AND PARTINERS ARCHITECTS.

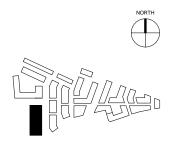

Revision description	Date	Check	Rev
PLANNING APPLICATION	12/02/18	BJ	-
PLANNING SUBSTITUTION DRAWINGS	01/03/19	EmK	Α

SQUIRE & PARTNERS

The Department Store 248 Ferndale Road London SW9 8FR T: 020 7278 5555 F: 020 7239 0495

1. 020 / 2/8 3333 F. 020 / 239 049

info@squireandpartners.com www.squireandpartners.com

Project Stag Brewery

Richmond

Drawing

Z3 SCHOOL - PROPOSED ROOF PLAN

Drawn	Date	Scale	
RKL	01/17/18	1:200 @ A1 1:400 @ A3	
Job Number	Drawing number	Revision	
16019	C645_Z3_P_RF_001	А	

Appendix B

Appendix 7



BRIEFING PAPER – CONFIDENTIAL

PROJECT:	Reselton Properties Limited – Stag Brewery
SUBJECT:	Sport and Leisure Facilities within Proposed Development
DATE:	April 2019
VERSION:	5.0

1. Introduction

- 1.1 This Sport and Leisure Facilities Briefing Paper has been prepared by The Sport, Leisure and Culture Consultancy on behalf of Reselton Properties Limited ('the Applicant') in support of three linked planning applications for the comprehensive redevelopment of the former Stag Brewery Site in Mortlake ('the Site') within the London Borough of Richmond Upon Thames ('LBRuT').
- 1.2 The former Stag Brewery Site is bounded by Lower Richmond Road to the south, the river Thames and the Thames Bank to the north, Williams Lane to the east and Bulls Alley (off Mortlake High Street) to the west. The Site is bisected by Ship Lane. The Site currently comprises a mixture of large scale industrial brewing structures, large areas of hardstanding and playing fields.
- 1.3 The redevelopment will provide homes (including affordable homes), a Care Village for an older population, complementary commercial uses, community facilities, a new secondary school alongside new open and green spaces throughout. Associated highway improvements are also proposed, which include works at Chalkers Corner junction.
- 1.4 The three planning applications are as follows:
 - Application A hybrid planning application for comprehensive mixed use redevelopment of the former Stag Brewery site consisting of:
 - i. Land to the east of Ship Lane applied for in detail (referred to as 'Development Area 1' throughout); and
 - ii. Land to the west of Ship Lane (excluding the school) applied for in outline detail (referred to as 'Development Area 2' throughout).
 - Application B detailed planning application for the school (on land to the west of Ship Lane).
 - Application C detailed planning application for highways and landscape works at Chalkers Corner.
- 1.5 Full details and scope of all three planning applications are described in the submitted Planning Statement, prepared by Gerald Eve LLP.
- 1.6 This report addresses the loss of 2 youth 11v11 football pitches / 1 cricket pitch on the existing Site, and the need for and impact of the community sport and leisure provision included as part of the Application B.

2. Sport and Leisure Provision – Application B

- 2.1 The Application positions the school building in the eastern side of the existing playing field land.
- 2.2 A floodlit 3G football pitch (64m x 100m) with a total area (including run off) of 7,420m² is included west of the school building on the portion of the site bordering with Williams Lane.



- 2.3 The school building includes a 4-court sports hall designed to meet Sport England specifications (34.5m x 20m x 7.5m) and an activity hall / studio (10m x 15m).
- 2.4 A multi-use games area (26.5m x 36.3m) is included to the south of the school.
- 2.5 The school building also includes the following changing room provision:
 - Male changing room 68m²
 - Female changing room 69m²
 - Staff changing room 13m².
- 2.6 The southern portion of the existing playing field land south of the 3G football pitch is comprised of a Community Park bordering with Lower Richmond Road.

Figure 1: Site plan for relevant portion of site

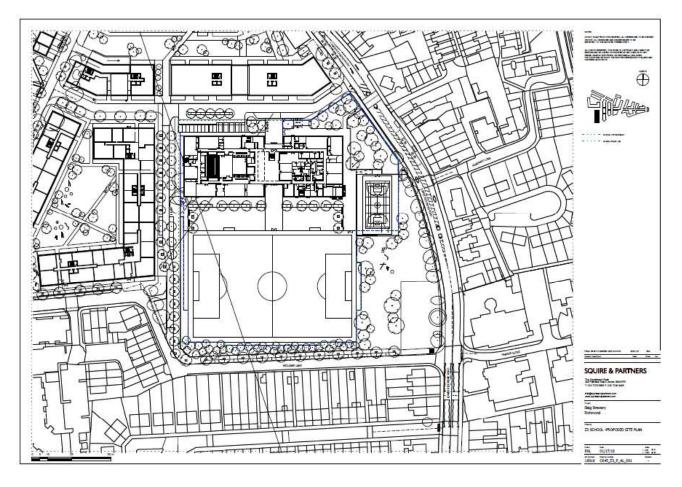




Figure 2: Proposed School Ground Floor Plan


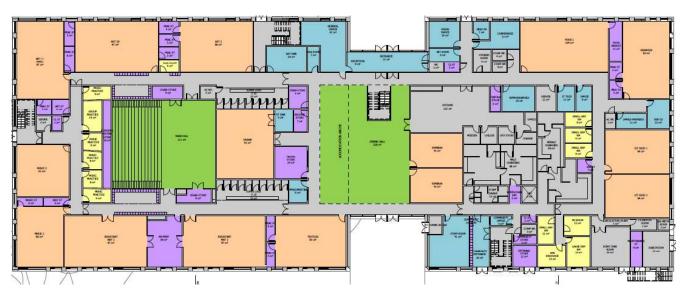


Figure 3: Proposed School First Floor Plan



3. Meeting the Requirements of Sport England Policy Exception E5

- 3.1 In respect of the loss of playing field land, the loss of existing sports facilities and pitches can be considered acceptable from a policy perspective <u>if</u> the conditions of at least one of Sport England's policy exceptions can be met.
- 3.2 The 2015 Playing Pitch Strategy for LBRuT found there to be a shortfall of youth 11v11 pitches in the borough of 1 match equivalent session in 2015, increasing to 14 match equivalent sessions in 2025. In the Richmond Analysis Area into which the site falls, supply and demand for 11v11 youth pitches is in balance currently, but there will be a shortfall of 6 match equivalent sessions in 2025.
- 3.3 There is also a current shortfall of Adult football pitches and mini pitches (7v7) and a projected future shortfall for all football pitch types with the exception of mini pitches (5v5) in 2025 in the Richmond Analysis Area.
- 3.4 The existing football pitches on the Site were not assessed as part of the 2015 Playing Pitch Strategy and not included in the calculation above. However, assuming the pitches are of

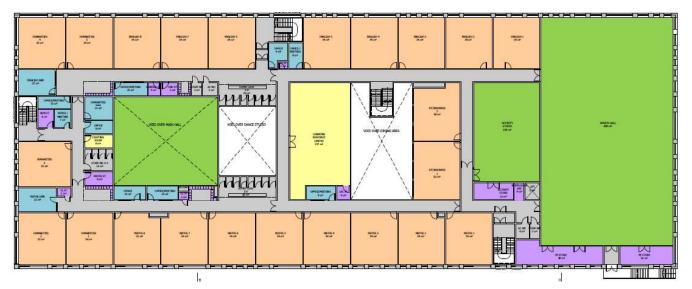

standard quality, each pitch will have a total capacity of 2 match equivalent sessions per week (4 match equivalent sessions per week in total).

- 3.5 If the pitches are of good quality the total capacity would increase to 3 match equivalent sessions per week per pitch 6 match equivalent sessions in total.
- 3.6 The playing fields are not currently used as a cricket pitch, but there is a suggestion that they may have historically been used for cricket in the summer months. LBRuT's Playing Pitch Strategy did not include the Site in its consideration of the existing cricket supply. The Strategy however, found that the current number of cricket squares in the borough can accommodate demand, and that there is spare capacity of 2 pitches in the Richmond Analysis area into which the site falls.
- 3.7 Although they were not included in the Playing Pitch Strategy calculations and therefore their loss would most likely not exacerbate the existing shortfalls, their loss cannot be justified on the basis that the pitches are surplus to requirements based on the current and future supply and demand balance for football pitches (Policy Exception E1).
- 3.8 Sport England's Policy Exception E5, however, would be applicable in the context of the revised proposal set out above if it can be demonstrated that the development of indoor and / or outdoor sports facilities as part of the proposal would be of sufficient sporting benefit to outweigh the detriment caused by the loss of the playing fields resulting from the development.
- 3.9 In order to understand and demonstrate if this is the case, it is necessary to establish:
 - What is the current use and what benefits are derived from that use?
 - What is the proposed use?
 - What sport-related benefits would be derived from the proposed use and how does this compare with the current use?
 - What role will the proposed development have in addressing existing deficiencies?

Current Use

- 3.10 The playing field land at the Site currently includes two grass 11v11 youth football pitches with no floodlighting.
- 3.11 The football pitches are currently in use by Barnes Eagles FC for their U13 to U16 teams. The Club's primary site is Barn Elms Sports Centre, and it only uses the pitches at the Site for 4 matches per week and occasional training during the football season.
- 3.12 The pitches are also used by Thomson House School for sports and games once a week on Tuesdays during term time, and once a year by St Mary Magdalen Catholic Primary School for their annual sports day.
- 3.13 Although the playing field land is described in the Adopted Planning Brief (2011) as consisting of 2 football pitches and 1 cricket pitch, the land has not been used as a cricket pitch for many years.
- 3.14 The total estimated current use of the playing field land in terms of annual participants is summarised in Table 1.



Use	Estimated Total Participants Per Annum	Assumptions
Thomson School	1,950	Once a week – c. 50 pupils per session
Barnes Eagles FC – Matches	4,200	2 matches per week per pitch during 35-week football season – c. 30 participants (11v11 plus substitutes)
Barnes Eagles FC – Training	1,050	Occasional training during 35-week football season (2 sessions per week – 15 participants per session)
St Mary Magdalen School	250	Annual sports day – whole school
Total	7,450	

 Table 1: Estimated Current Use of Playing Field Land - Annual participants

- 3.15 Given the limited carrying capacity of grass playing pitches, there is little or no scope to increase the number of participants within the current configuration. Significant additional use would have a detrimental impact on the quality and playability of the pitches.
- 3.16 It is conceivable that if the condition of the pitches is 'good' rather than 'standard' they would each have a carrying capacity of 3 matches per week which would increase the total annual participants by c. 2,100 to c. 9,550, but this would be the maximum threshold of users that can currently be achieved.

Proposed Use

- 3.17 The Application includes the following in terms of sports facilities:
 - 3G youth football pitch (64m x 100m) with floodlights (120lux or 200lux)
 - 4 court sports hall meeting Sport England specifications (34.5m x 20m x 7.5m)
 - Activity hall / studio (150m²)
 - Multi-use games area (26.5m x 36.3m)
 - Changing provision including male, female and staff change.
- 3.18 Table 2 shows an estimate of the potential capacity of the sports facilities included in the proposal in terms of participants per annum using the following assumptions:
 - 3G pitch benefits from floodlighting
 - Facilities are available for community use from 5pm to 9pm on weekdays during term time (39 weeks per annum).
 - Facilities would primarily be used for after-school activities between 4pm and 5pm on weekdays during term time. Community use between the hours of 4pm and 5pm on weekdays during term time will be at the discretion of the school
 - Facilities are available for community use from 9am to 9pm on weekdays outside of term time (11 weeks per annum)
 - Facilities are available for community use from 9am to 9pm on Saturdays
 - Facilities are available for community use from 9am to 8pm on Sundays and Public / Bank Holidays



- MUGA does not benefit from floodlighting
- MUGA is available for community use during daylight hours from 5pm to 9pm on weekdays, from 9am to 9pm on Saturdays and from 9am to 8pm on Sundays and Public / Bank Holidays during term time (39 weeks per annum) – an average of c. 28 hours per week across the year
- MUGA is available for community use during daylight hours from 9am to 9pm Monday to Saturday and from 9am to 8pm on Sundays and Public / Bank Holidays outside of term time (11 weeks per annum) an average of c. 67 hours per week across the year
- All community use sessions are hourly with the exception of the 3G pitch where 2-hour match equivalent sessions have been used, albeit it is common practice for 3G pitches to be hired on an hourly basis
- All students at the secondary school (1,500 pupil capacity) use at least one of the sports facilities on site at least once a week during term time.
- 3.19 Table 3 also shows the potential capacity of the facilities if the opening hours were extended to a 10pm closure on weekdays and weekends.
- 3.20 It should be noted that the availability of the facilities for community use outside of school hours would not preclude the secondary school from reserving the use of the facilities during these times for extra-curricular activities. Usage by the school between the hours of 4pm to 9pm or 10pm on weekdays during term time has not been distinguished from usage by the community in the estimated capacity calculations in Tables 2 and 3.

Facility	Estimated number of users per session	Term Time capacity	Non-Term Time capacity	Total
Opening Hours	Weekdays (Term Tir Weekdays (Non-Ter Saturdays: 9am – 9p	m Time): 9am –		
	Sundays and Public	/ Bank Holidays	: 9am – 8pm	
3G Youth Football Pitch	22	20,592	10,043	30,635
4 Court Sports Hall	10	18,720	9,130	27,850
Activity Hall / Studio	20	37,440	18,260	55,700
MUGA	10	12,480	7,392	19,872
Total Use outside of School Hours	n/a	89,232	45,793	134,057
School Use	n/a	58,500	n/a	58,500
Total Use	n/a	147,732	45,793	192,557

Table 2: Estimated capacity of Application B Sports Facilities - Users per annum. Earlierclosing times



Table 3: Estimated capacity of Application B Sports Facilities - Users per annum. Laterclosing times

Facility	Estimated number of users per session	Term Time capacity	Non-Term Time capacity	Total
Opening Hours	Weekdays (Term Tir Weekdays (Non-Ter Weekends: 9am – 1	m Time): 9am –		
3G Youth Football Pitch	22	24,024	11,011	35,035
4 Court Sports Hall	10	21,840	10,010	31,850
Activity Hall / Studio	20	43,680	20,020	63,700
MUGA	10	12,480	7,392	19,872
Total Use outside of School Hours	n/a	102,024	48,433	150,457
School Use	n/a	58,500	n/a	58,500
Total Use	n/a	160,524	48,433	208,957

- 3.21 Table 2 shows that the sports facilities included in the Application could accommodate up to **192,557** attendances per annum. The capacity may even be slightly higher as school use would most likely be more frequent that 1 use per student per week. If longer opening hours were to be put in place, this potential capacity would increase to **208,957** attendances per annum.
- 3.22 It should be noted that these calculations show capacity rather than projected use and include some school usage, including after-school sessions between the hours of 4pm and 5pm on weekdays during term time The facilities would be unlikely to experience full occupancy levels, but in an area of high demand it would be reasonable to expect occupancy levels of c. 65% of community use hours for the MUGA, c. 75% of community use hours for the studio and sports hall and c. 80% of community use hours for the 3G pitch.



Table 4 and Table 5 show the capacity of the facilities if only community use is considered. The same assumptions as provided in 3.18 and 3.19 have been applied but only capacity during the community use hours shown has been considered.



3.23 Table 4 is based on a 9pm closure on Monday – Saturday and 8pm on Sundays, whilst Table 5 shows the capacity if opening hours were extended until 10pm.



Table 4: Estimated Community Use capacity of Application B Sports Facilities - Users per	
annum. Earlier closing times	

Facility	Estimated number of users per session	Term Time capacity	Non-Term Time capacity	Total
Community Use Hours	Weekdays (Term Tir Weekdays (Non-Ter Saturdays: 9am – 9p	m Time): 9am –	9pm	
	Sundays and Public	/ Bank Holidays	: 9am – 8pm	
3G Youth Football Pitch	22	18,447	10,043	28,490
4 Court Sports Hall	10	16,770	9,130	25,900
Activity Hall / Studio	20	33,540	18,260	51,800
MUGA	10	10,920	7,392	18,312
Total Community Use	n/a	79,677	44,825	124,502

Table 5: Estimated capacity of Application B Sports Facilities - Users per annum. Later closing times

Facility	Estimated number of users per session	Term Time capacity	Non-Term Time capacity	Total
Community Use Hours	Weekdays (Term Tir Weekdays (Non-Ter Weekends: 9am – 1	m Time): 9am –		
3G Youth Football Pitch	22	19,734	11,011	30,745
4 Court Sports Hall	10	17,940	10,010	27,950
Activity Hall / Studio	20	35,880	20,020	55,900
MUGA	10	10.920	7,392	18,312
Total Community Use	n/a	84,474	48,433	132,907



- 3.24 Table 4 shows that the sports facilities included in the Application could accommodate significant community use of up to **124,502** attendances per annum. The capacity may even be slightly higher as additional community use could be accommodated between 4pm and 5pm on weekdays during term time at the school's discretion. If longer opening hours were to be put in place, this potential capacity would increase to **132,907** attendances per annum, as shown in Table 5.
- 3.25 Two options for floodlighting of the 3G pitch have been tested and are acceptable. The applicant's preference is to proceed with 120lux at this stage. This level of lighting would still be suitable for evening use for training purposes and for matches at lower levels of competition. This should not materially affect overall potential capacity levels of the pitch in terms of users as the majority of evening use at a community facility would be for training purposes rather than competitive matches.

Sport-related benefits

- 3.26 There are number of sport-related benefits associated with the development of the sports facilities included in the Application.
- 3.27 The most significant sport-related benefit associated with the Application is the increased user-capacity of the new facilities compared with those currently in place. There is capacity for up to an additional **183,007** users per annum if the 3G pitch has the benefit of floodlighting to facilitate evening use an increase of **1,916%**. This would increase to up to an additional **199,407** users per annum (**2,088%**) with longer opening hours.
- 3.28 This includes an additional community-use capacity of up to 124,502 users per annum or 132,907 users with longer opening hours.
- 3.29 The proposal also has the benefit of providing facilities for a significantly increased range of sports, including:
 - 3G football pitch
 - Football 11v11, 7v7, 5v5 and training
 - Rugby training
 - 4 court sports hall
 - o Badminton
 - Gymnastics
 - o Futsal
 - o Fencing
 - o Table tennis
 - Indoor football (5v5)
 - Volleyball
 - o Handball
 - o Indoor Basketball
 - o Indoor Netball
 - Indoor cricket nets
 - Activity Hall / Studio