

Project Name:	Friars Stile Road, Richmond
Document Reference:	517.0006/TN/2
Document Name:	Technical Note
Prepared By:	Izzie Diment (August 2023)
Checked By:	Tom Peters (August 2023)
Approved By:	James Rand (August 2023)

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1. INTRODUCTION

1.1 This Technical Note (TN) has been prepared by Paul Basham Associates on behalf of the Malins Group to support an application for the construction of a single dwelling, replacing 7 garages in Richmond. The site is to the rear of commercial properties fronting onto Friars Stile Road and access will be provided in this same location. The location is shown in Figure 1.



Figure 1: Site Location

 Pre-Application has been undertaken with London Borough of Richmond Upon Thames (LBRT) under planning reference: 22/P0367/PREAPP in December 2022, with highways making comments on the required level of parking.



1.3 This Technical Note will explore the existing conditions, collision data, development proposals and trip generation before drawing conclusions.

2. EXISTING CONDITIONS AND SITE ACCESSIBILITY

2.1 The site currently comprises 7 x garages and is adjacent to amenities on Friars Stile Road, located approximately 800m south of Richmond High Street. The site is bound to the north by Onslow Road, to the east by local shops and to the west and south by residential dwellings and gardens.

Local Road Network

2.2 Onslow Road is a single carriageway road that measures approximately 6.5m in width and is subject to a 20mph speed limit. On street parking bays are present, with single yellow lines present in all other locations. The demarcated parking bays are resident permit holders only or pay by phone for a maximum of 4 hours between Mon – Sat, 8:30am – 6:30pm. Onslow Road meets a priority junction with Friars Stile Road to the east, which is a single carriageway road that measures approximately 6.5m in width and is also subject to a 20mph speed limit.

Pedestrian Network

2.3 Pedestrian facilities within proximity of the site are excellent. Continuous footways flank both sides of Onslow Road that measure approximately 2m wide. Continuous footways also flank both sides of Friars Stile Road measuring approximately 2m wide. There are also pedestrian crossing points with dropped kerbs and tactile paving present in appropriate locations to facilitate the safe movement of pedestrians.

Public Transport Accessibility Level

2.4 The PTAL (Public Transport Accessibility Level) of the site is 1b as demonstrated in **Figure 2**. The nearest bus stops to the site are the 'St Matthias Church' bus stops, located approximately 120m north (southbound bus stop) and 170m northbound (southbound bus stop). These bus stops provide services to the surrounding areas via the 371 bus service that runs from Kingston-upon-Thames to Richmond approximately every 10 minutes Monday - Sunday.



2



2.5 Furthermore, Richmond train station is located approximately 820m north of the site, and facilitates travel into Central London via the London Overground service, the District Line and South Western Railway services into London Waterloo.



Figure 2: PTAL Score for the Site

Personal Injury Accident (PIA) Data

2.6 The PIA Data for the most recent 5-year period (2017 – 2021) has been obtained from Crashmap. The results are summarised within Figure 3 below.



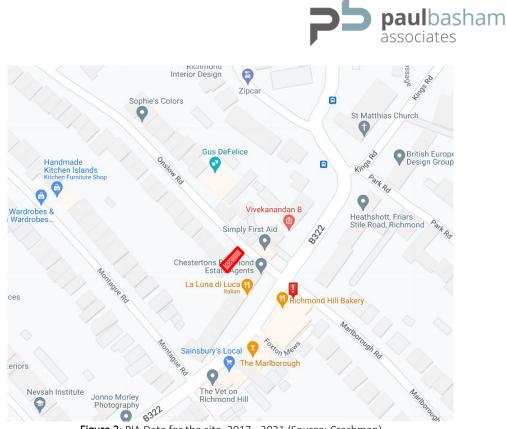


Figure 2: PIA Data for the site, 2017 - 2021 (Source: Crashmap)

2.7 There has been 1 incident that has occurred over the last 5 years within proximity to the site, on the corner of Marlborough Road and Friars Stile Road which was classified as 'serious' in nature. Upon a more detailed inspection of the incident, it occurred on the 20th October 2018, between a goods vehicle and a pedestrian. Taking into consideration the frequency and distribution of incidents that have occurred within proximity to the site and the fact that this is the only identified incident that has occurred within a 200m radius of the site over the last five years, it has been deduced that the incident most likely occurred either due to driver error or pedestrian error rather than highway design.

3. PROPOSED DEVELOPMENT

- 3.1 The proposed development consists of the demolition of 7 existing garages and the development of 1 x 3-bedroom dwelling at Friars Stile Road, Richmond. The proposed layout is attached as **Appendix A**.
- 3.2 Parking for the proposed dwelling will be accessed off Onslow Road via the existing access arrangement in place for the garages, which will measure 5.5m wide.

Parking

3.3 In accordance with LB Richmond upon Thames's Parking SPD, parking standards from the London Plan are applicable. For 3+ bedrooms in outer London with PTAL scores of 0-1, the maximum level of provision is 1.5 spaces per dwelling. Given the development consists of a



single dwelling, and the pre-application response from LBRT, this has been rounded to 2 spaces, provided as shown on the site layout. This should not result in any overspill parking on the local road network.

3.4 In accordance with the London Plan, cycle parking for two bicycles will be provided as shown on the site layout.

Servicing

3.5 Refuse collection will occur from Onslow Road, in keeping with other properties on the road. Furthermore, a fire tender is able to get within 45m of all parts of the building from Onslow Road.

4. HIGHWAY IMPACT

4.1 This section of the TN will assess the net trip generation associated with the proposed development.

Existing Trip Generation

4.2 It is difficult to accurately quantify the trip generation of the existing 7 garages. If each garage is visited once per day, 14 trips would be generated. It is likely that activity is less frequent at the present time, but lawfully they could generate a significant number of daily trips.

Proposed Trip Generation

- 4.3 In order to determine the likely trip generation for the proposed use, the TRICS database has been utilised. The following parameters were selected:
 - Use class 'Residential' and sub category 'Houses privately owned';
 - Sites in Greater London only;
 - Parameter of 6 -50 units;
 - Weekday surveys only; and
 - Sites in 'Edge of Town centre' and 'Suburban Area' only.
- 4.4 The results of the TRICS assessment are summarised below in **Table 1**, with the full outputs attached as **Appendix B**.





	AN	1 Peak (0800-09	00)	P	Daily (12		
	Arrivals	Departures	Totals	Arrivals	Departures	Totals	hours)
Trip Rate	0.183	0.293	0.476	0.207	0.134	0.341	5.123
Trip Generation (1 dwelling)	0	0	1	0	0	0	5

 Table 1: Proposed Development Trip Generation (TRICS v.7.10.1)

- 4.5 The proposed development is likely to generate in the order of 1 trip in the AM peak, 0 trips in the PM peak, with 5 trips generated across a 12 hour period.
- 4.6 It is considered that the change in trips generated by the site is likely to be negligible, or indeed could constitute a reduction given that the garages could generate a higher number of trips within their lawful use.

5. SUMMARY AND CONCLUSIONS

- 5.1 This Technical Note (TN) has been prepared by Paul Basham Associates on behalf of the Malins Group to support an application for the construction of a single dwelling, replacing 7 garages in Richmond.
- 5.2 The site is adjacent to amenities and located approximately 800m south of Richmond High Street. It is near bus stops located approximately 120m north (southbound bus stop) and 170m northbound (southbound bus stop).
- 5.3 The proposed development would be accessed off Onslow Road, as per the existing garages. The development will provide 2 car parking spaces and 2 cycle parking spaces, which is considered appropriate with reference to the London Plan standards.
- 5.4 It is proposed that refuse collection will occur on-street, as per the existing arrangement currently in operation along the residential streets within Richmond. A fire tender is also able to get within 45m of all parts of the building.
- 5.5 The proposed development is likely to generate in the order of 1 trip in the AM peak, 0 trips in the PM peak, with 5 trips generated across a 12 hour period. When compared to the existing garages, the proposed development is likely to result in a negligible change, or potentially a reduction in trips when compared to the existing garages on the site.






5.6 It is therefore considered that there are no highways reasons to resist approval and we would therefore encourage LB Richmond upon Thames Council to look favourably upon this application in relation to highways.




Appendix A



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Indicates new trees / shrubs to LA approval.

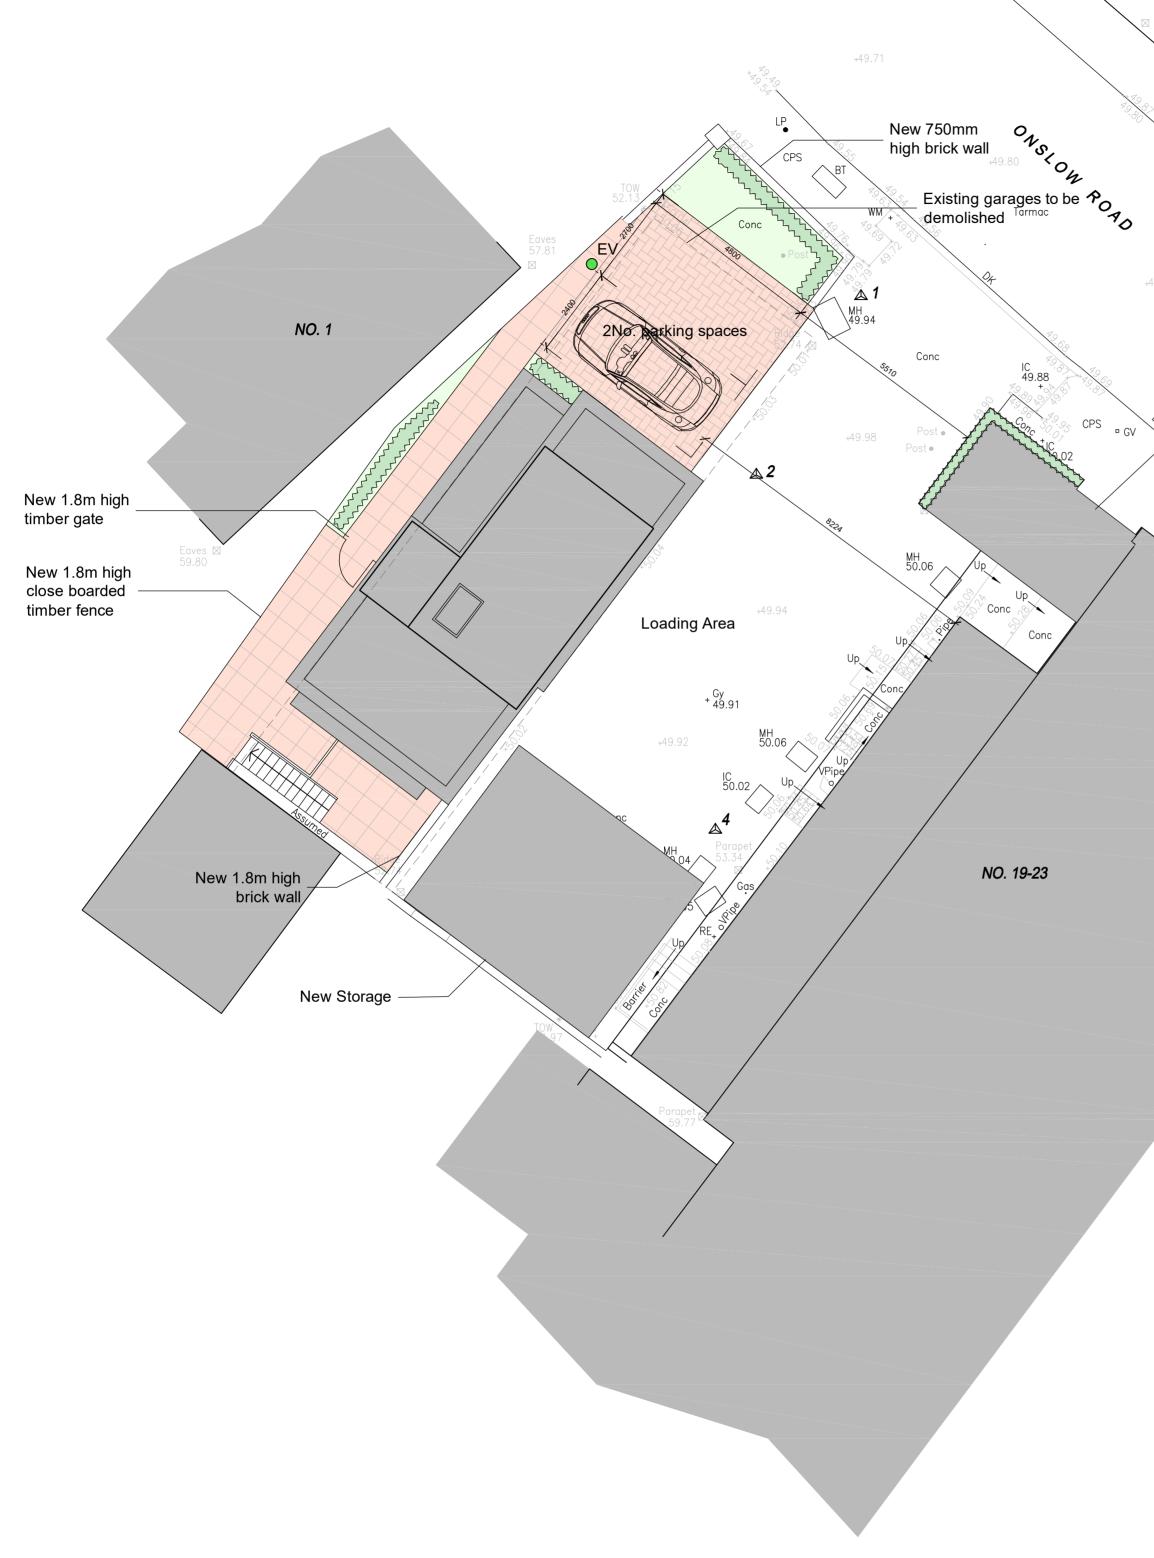trees / shrubs.

NOTES

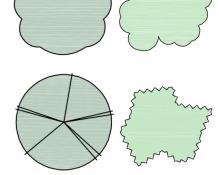Hard Landscaping



Block Paving



parking bays.

Herringbone pavers to




Electric Vehicle Charging Point


Boundary treatment details



Close boarded timber fence.

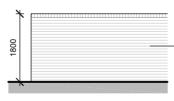

_1.8m high brickwork wall.

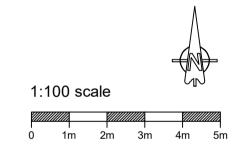

P5	July 2023	Minor amendments	LW	
P4	July 2023	Added dimensions	НМ	
P3	June 2023	Amendments based on pre-app comments	НМ	
P2	Nov 2022	Amendments to suit client comments	LW	
Revision	Date	Description	Dwn	Chkd



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E-Mail: admin@plcarchitects.com ARCHITECTS Web: www.plcarchitects.com

Client :

Project: Land at rear of 19-23 Friars Stile Road Richmond TW10 6NH

Drawing Title :

Proposed Site Plan

Drawn By	Oct '22	ecked By Date	Approved By Date
Drawing No. 22.3349.	102	P5	Scale: 1:100 @ A2
	ITECTS © E SCALED. DIMEN NG ONLY FOR LOO	SIONS TO BE C	



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Appendix B



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asham Associates Hambl	e Lane Southampton			Licence No: 2476
			Calculation Referen	ce: AUDIT-247601-230504-05
TRIP RATE CALCULATIO	ON SELECTION PARAN	/IETERS:		
Land Use : 03 - RESII	DENTIAL			
Category : A - HOUSE	ES PRIVATELY OWNED			
MUĽTÍ-MODAL TOT	AL VEHICLES			
Selected regions and area	75'			
01 GREATER LONDON	N			
EN ENFIELD			1 days	
HO HOUNSLOW			1 days	
Primary Filtering select	ion			
Frindly Filtering select				
Parameter:	No of Dwellings			
Actual Range:	32 to 50 (units:)			
Range Selected by User:	9 to 50 (units:)			
Parking Spaces Range:	All Surveys Included			
Parking Spaces per Dwelli	ng Range: All Surveys I	ncluded		
Bedrooms per Dwelling Ra	ange: All Surveys I	ncluded		
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Southampton

Secondary Filtering selection (Cont.):

Hamble Lane

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<u>Population within 5 miles:</u> 500,001 or More	2 days
<u>Car ownership within 5 miles:</u> 0.6 to 1.0 1.1 to 1.5	1 days 1 days
<u>Travel Plan:</u> No	2 days
<u>PTAL Rating:</u> 1b Very poor 3 Moderate	1 days 1 days

TRICS 7.10.1 180423 B21.30 Database right of TR 517.0006 TR	ICS Consortium Limited	d, 2023. All rights reserved	Thursday 04/05/23 Page 3
Paul Basham Associates Hamble Lane Southampt	ton		Licence No: 247601
LIST OF SITES relevant to selection parameter	re		
LIST OF STILS TELEVANT to Selection parameter	<u>-</u>		
1 EN-03-A-01 TERRACED & SEN BOLLINGBROKE PARK COCKFOSTERS	/II -DETACHED	ENFIELD	
Edge of Town Residential Zone Total No of Dwellings:	32		
<i>Survey date: WEDNESDAY</i> 2 HO-03-A-02 MIXED HOUSES	24/11/21	<i>Survey Type: MANUAL</i> HOUNSLOW	
HIBERNIAN ROAD HOUNSLOW		HOUNSLOW	
Edge of Town Centre Residential Zone			
Total No of Dwellings: <i>Survey date: MONDAY</i>	50 <i>29/06/15</i>	Survey Type: MANUAL	
MANUALLY DESELECTED SITES			
Site Ref	Reason for Deselectio	n	
EN-03-A-02 Location not representative	9		

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TRIP RATE for Land Use 03 - RESIDENTIAL/A - HOUSES PRIVATELY OWNED MULTI-MODAL TOTAL VEHICLES Calculation factor: 1 DWELLS BOLD print indicates peak (busiest) period Total People to Total Vehicles ratio (all time periods and directions): 2.45

	ARRIVALS				DEPARTURES			TOTALS		
	No.	Ave.	Trip	No.	Ave.	Trip	No.	Ave.	Trip	
Time Range	Days	DWELLS	Rate	Days	DWELLS	Rate	Days	DWELLS	Rate	
00:00 - 01:00										
01:00 - 02:00										
02:00 - 03:00										
03:00 - 04:00										
04:00 - 05:00										
05:00 - 06:00										
06:00 - 07:00										
07:00 - 08:00	2	41	0.024	2	41	0.171	2	41	0.195	
08:00 - 09:00	2	41	0.183	2	41	0.293	2	41	0.476	
09:00 - 10:00	2	41	0.098	2	41	0.171	2	41	0.269	
10:00 - 11:00	2	41	0.134	2	41	0.171	2	41	0.305	
11:00 - 12:00	2	41	0.171	2	41	0.110	2	41	0.281	
12:00 - 13:00	2	41	0.268	2	41	0.183	2	41	0.451	
13:00 - 14:00	2	41	0.171	2	41	0.244	2	41	0.415	
14:00 - 15:00	2	41	0.183	2	41	0.146	2	41	0.329	
15:00 - 16:00	2	41	0.256	2	41	0.220	2	41	0.476	
16:00 - 17:00	2	41	0.146	2	41	0.134	2	41	0.280	
17:00 - 18:00	2	41	0.207	2	41	0.134	2	41	0.341	
18:00 - 19:00	2	41	0.244	2	41	0.146	2	41	0.390	
19:00 - 20:00	2	41	0.244	2	41	0.171	2	41	0.415	
20:00 - 21:00	2	41	0.280	2	41	0.220	2	41	0.500	
21:00 - 22:00										
22:00 - 23:00										
23:00 - 24:00										
Total Rates:			2.609			2.514			5.123	

Parameter summary

Trip rate parameter range selected:32 - 50 (units:)Survey date date range:01/01/15 - 14/09/22Number of weekdays (Monday-Friday):2Number of Saturdays:0Number of Sundays:0Surveys automatically removed from selection:0Surveys manually removed from selection:1