NBS Specification: Q37

BIODIVERSE ROOF SPECIFIATION Contractor Design Element; subject to equal & approved spefication

Drainage Layer
Material: Thermoformed recycled polypropylene TBC by specialist controctor design / consultant civil

- Retention Volume Horizontal Flow Rate
- Vertical Flow Rate:
- Compressive Strength: 150kPa

Filter Membrane Material: Thermally strengthened non-woven

- polypropylene
 Mass: 0.120 kg/m2

Extensive Biodiverse Substrate

Material: Lightweight crushed brick & expanded clay substrate. Inorganic and organic growing medium consisting of crushed brick, expanded clay and organic matter of composted bark fines

- Depth: 80-150mm
- Porosity: 63% Water Holding Capacity: 25-30% Bulk Density DIN EN 1097-3: 1 T/m3
- Density at Max Water Holding Capacity: 1.25

PH Value: 7.0 8.0Vegetation Planting Mix: Various wildflower species in plug plant trays and seed form Root Ball Size (plugs): 50mm Coverage Rate (seeds): Varies; up to 5g/m2 Coverage Rate (Plugs): 10 per m2

Habitat Creation / Biodiversity Enhancements

Edge Retaining/Separating Profile Material: Aluminium

- Description/Profile: Slotted; 3m length Height: 100mm (subject to system
- build-up/depth)

Inspection/Access Chambers

- Material: Plastic coated stee Dimensions: 250x250mm
- Height: 80mm Colour: Black
- Access Covers: Black, plastic coated steel with
- Features: 300x 300mm flange attached for stability and to lap filter sheet

Vegetation Barrier Material: Rounded washed pebbles (20-40mm) Depth: 70mm (subject to system

build-up/depth)
Width: 300mm minimumExecution

- Installation Generally

 Preparation: Clear all surfaces of debris Timing: After certification of waterproo
- membrane integrity Surface condition: Visually inspect waterproof
- membrane, report any damage
 Faults in waterproof membrane: Report prior to
- commencement of works
- Contamination: Do not use materials detrimental to healthy growth of plants
- Storage: Do not overload point loads avoided
- Outlets: Do not block Outlet grilles: Installed


Adverse Weather

- Unfinished work: Secure for damage and wind
- Conditions: Do not install or work with frozen

Drainage Layer Installation

- Extent: Loose lay continuously over entire roof
- Fitting: Close butt-joint boards or rolls;
- staggering joints if applicable
 Upstands: Cut to fit 300mm from penetrations
- and outlets, using a heavy duty knife or smooth-toothed saw

- Filter Membrane Installation
 Extent: Loose lay continuously over entire roof
- Fitting: Loose laid (bonded to drainage board)
 Joints: Minimize
- Overlaps (minimum): 150mm overlap excess on drainage roll

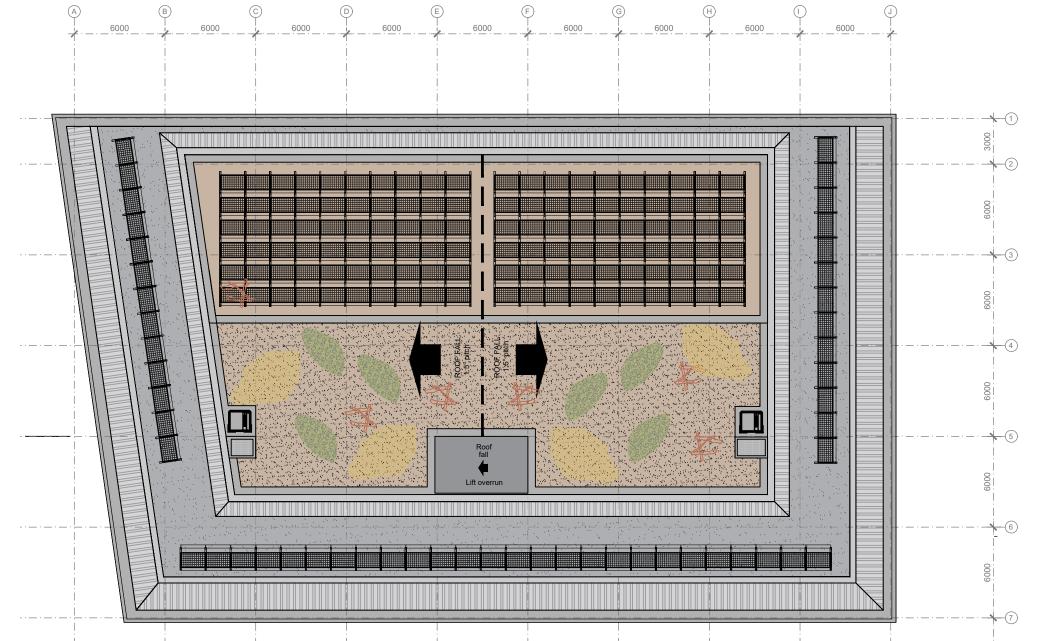

Growing Medium Installation Handling: Minimize handling. Deliver to roof in small

sacks, bulk bag or pump,spreading the specified depth on to filter sheet, allowing the settlement factor of 20%

Conditions: Handle in the driest condition possible Do not handle or install when wet or frozen

- Depth: 80-150 mm settled
- Sequence: Gently firm each layer before spreading the next.Vegetation Installation

- Handling Seeds:
 Extent: Continuous and even across area to be
- Timing: Not to be installed if temperature is
- below 0C Storage: Must be stored in a cool and shaded
- area; not to be stacked excessively

Application

- . Wildflower seeds to be installed within 48 hours
- of delivery. Irrigate to saturation.

 Watering: Thoroughly, after laying and account
- for climatic variation and seasonalit

Edge Retaining Profile Installation

- Cutting: Neat, accurate and without spalling Junctions: vertical, secured using proprietary
- Position: True to line and level, Smooth

- Inspection Chamber Installation Location: Install centrally over rainwater outlet Orientation: Align parallel with adjacent
- features
 Bedding: Position flanges on to crowns of
- drainage layer
 Backfill: Ballast flanges with pebbles Surround: 300mm diameter circle/square of 20-40 rounded pebbles

COMPLETION

Inspection
Timing: Prior to handover Notice period (minimum): 3 working days

Completion General: Leave the works in a clean and tidy

Surfaces: Clean immediately prior to handover Outlets: Clean and clear of any obstructions
Completed green roofs: Protect from adjacent or high level working as best as possible.

Timing: Submit at handover

- Growing Medium declaration of analysis
- Manufacturers guarantees and warranties
- continuous lines
 Fixing: Loose laid onto fleece, ballasted by Record Drawings showing the location of
- weight on foot plate, or secured to waterproof membrane using proprietary fixing system
 Suitable for pitched roofs of 5 degrees or less

Green Roofs Maintenance Procedure

This set of procedures is a guide outlining the minimum maintenance measures required to keep a green roof in its designed state.

planting and associated features Number of copies: 1

The plant selection includes a species mix which will provide a balanced plant community on the roof.
This will require basic maintenance to ensure a sustainable system for the long term

four times annually, during springtime and in late autumn, or as required. Monitoring/controlling the effect of leaf litter to the vegetation is important; this can be deemed to be beneficial to biodiversity, but may need to be removed if this begins to affect plant

EGR SPECIES MIX [subject to specialist contractor design]

Wildflower Species Flower Birdsfoot Trefoil - Lotus corniculatus

Black Medick - Medicago Iupulina Common Knapweed - Centaurea nigra Corn Chamomile - Anthemis arvensis Corn Cockle - Agrostemma githago Corn Marigold - Chrysanthemum se Cornflower- Centaurea cyanus Cowslip- Primula veris Field Forget-Me-Not - Myosotis arvensis Field Poppy - Papaver rhoeas Foxglove- Digitalis purpurea Goatsbeard - Tragopogon Greater Knapweed- Centaurea scabiosa Hoary Plantain- Plantago media Ladys Bedstraw- Galium verum Meadow Buttercup- Ranunculus acris Musk Mallow - Malva moschata Night-flowering Catchfly Silene noctiflora
Ox-eye Daisy- Leucanthermum vulgare Red Campion- Silene dioica Ribwort Plantain- Plantago lanceolata White/pink Salad Burnet- Sanguisorba minor ssp minor Self Heal Prunella- vulgaris

Sorrel- Rumex acetosa

Wild Carrot- Daucus carota Wild Clary- Agrimonia

Companion grasses

Common Bentgrass- Agrostis castellana Crested Dogstail- Cynosurus cristatus Sheep's Fescue- Festuca ovina Smooth Stalked Meadow Grass- Poa pratensis Strong Creeping Red Fescue- Festca rubra rubra

Sedum species: Sedum Acre Aureum Sedum Album Athoun Sedum Reflexum Sedum Voodoo Sedum Album Coral Carpet

NOTES

All levels and dimensions to be checked on site prior to construction / fabrication; report discrepancies immediately Do not scale dimensions from this drawings.

REVISION

A 200324 PV provision increased

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AF

ORIGINAL A3

Material Key:




Biodiverse Roof with 500mm gravel strip to perimeter




Photovoltaic panels on proprietary feet system Brown roof below PV Panels. 170Nr panels - Area circa 300sqm.



Lift Overrun, insulated panel

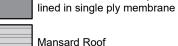

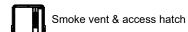



SCALE 1:250





PLANNING

DATE

DRAWN CHECKED

1:250@A3 MAR'24 ΑF DA

PROJECT

SCALE

Shurgard Oldfield Road Hampton: TW12 2HR

DRAWING

Roof Plan As Proposed



10 MONTROSE STREET GLASGOW G1 1RE

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