

VOLUME CALCULATION ;

DORMER :

$(P-6.01) \times (Q-3.90) \times (R-2.66) \times \frac{1}{2} = 31.17 \text{ M}^3$


HIP TO GABLE:

$(A-8.39) \times (B-2.91) \times (C-4.00) \times \frac{1}{6} = 16.27 \text{ M}^3$

TOTAL: 47.44 M<sup>3</sup>




Proposed Front Elevation  
Scale:1:100

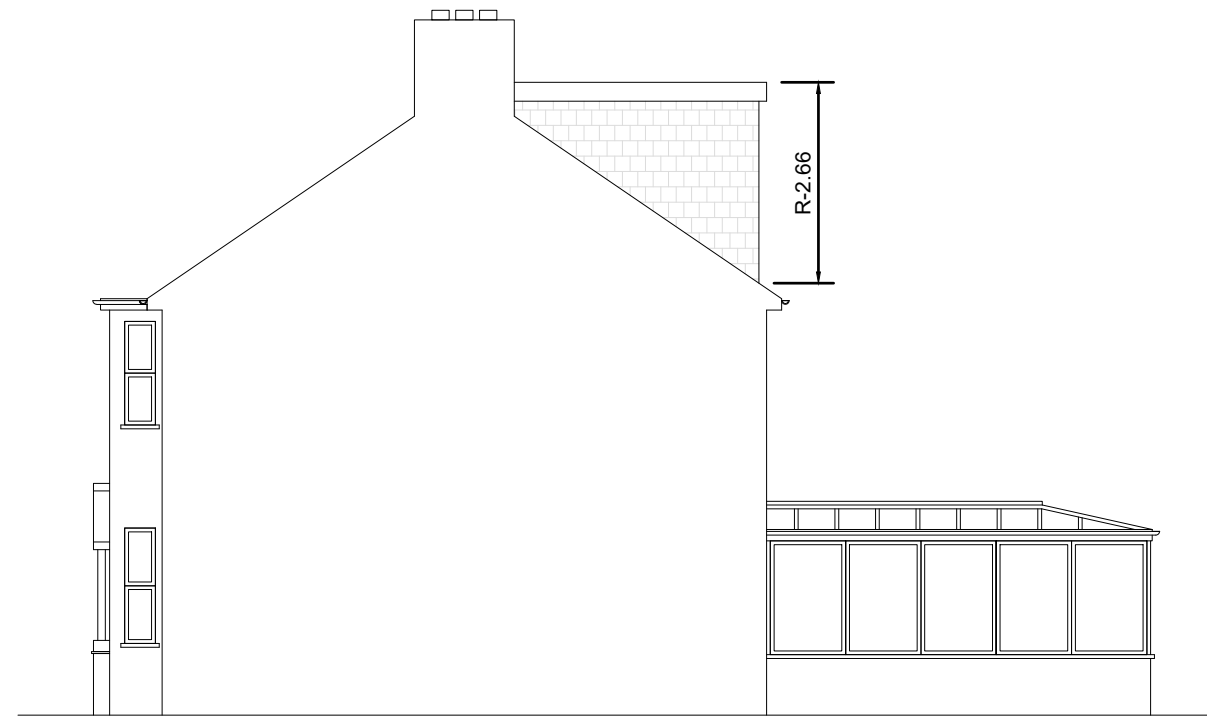

Proposed Side Elevation  
Scale:1:100



Proposed Rear Elevation  
Scale:1:100

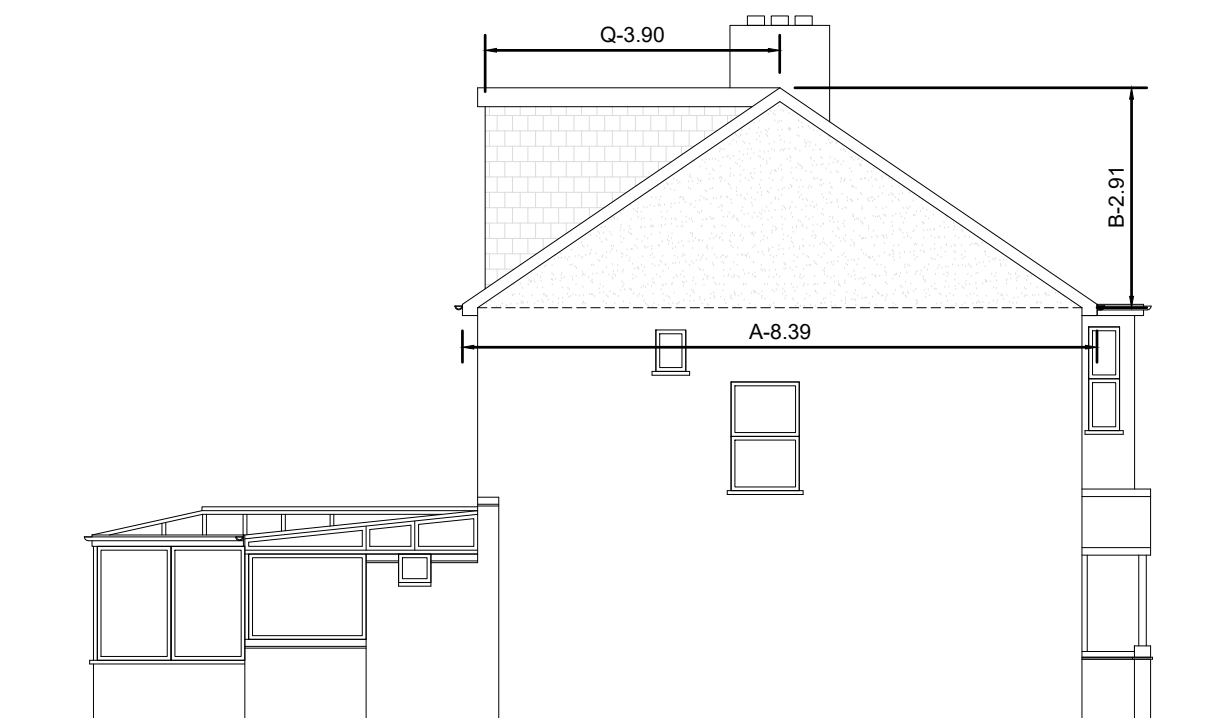


Proposed Side Elevation  
Scale:1:100

Notes:

- 1) The materials used in any exterior work will be of a similar appearance to those used in the construction of the exterior of the existing dwellinghouse.
- 2) The window/s inserted on the wall or roof slope forming a side elevation of the dwellinghouse will be obscure-glazed, and non-opening unless the parts of the window which can be opened are more than 1.7 metres above the floor of the room in which the window is installed".
- 3) The rooflights will not protrude more than 150mm beyond the plane of the slope of the original roof.



 <p>Dimensions to be verified on site DO NOT SCALE FROM THIS DRAWING. Any areas indicated on this drawing are for guidance only. No responsibility is taken for their accuracy.</p> <p>This drawing is the property of <b>BANCIL PARTNERSHIP LTD</b> Copyright is reserved by them and the drawing is issued on the condition that it is not copied, reproduced, retained or disclosed to any unauthorised person, either wholly or in part without the consent in writing of <b>BANCIL PARTNERSHIP LTD</b></p>	Site Address:	Client Detail:	Title:	Drawn By: NM	Revisions:	
	8 Popham Gardens Richmond Surrey TW9 4LJ	8 Popham Gardens Richmond Surrey TW9 4LJ	Proposed Elevations	Checked By: SM	Rev	Revision
131 Heston Road, Hounslow, Middx, TW5 0RD Tel: 020 8574 4546 Fax: 020 8574 4526			Date: 03/2024			
			Scale: 1:100	Drawing No. PL1/SM/3389 - 04		
			Paper Size: A3			