


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REV.	DATE	DESCRIPTION	DESIGNED BY	CHECKED BY
-	11.10.2019	INITIAL ISSUE	MC	KW
A	04.11.2019	LEVEL ADJUSTMENTS	MC	KW
B	04.06.2020	LEVEL ADJUSTMENTS, ADDITIONAL TREES TO GATEWAY BOUNDARY	SJ	RH
C	06.05.2020	MAIN VEHICULAR EXIT AMENDED	SJ	RH
D	15.05.2020	AMENDMENTS TO TREES AND LANDSCAPING	SJ	RH
E	27.05.2020	HABITAT PLANTING (SHOWN)	SJ	RH
F	25.07.2022	DESIGN REVIEW AMENDMENTS	DC	JF
G	04.11.2022	PLANT ENCLOSURE ADDED; AMENDMENT TO PLAY AREA	LW	JF
H	26.05.2023	HISTORIC ENGLAND FOR COMMENT	JF	JF
I	06.12.2023	UPDATE TO TREE SURVEY	LW	JF
J	19.02.2024	UPDATE TO HIGHWAYS COMMENTS	LW	JF

**NOTE:**  
 - DRAWINGS ARE DESIGN INTENT FOR THE PURPOSE OF PLANNING APPROVAL.  
 - ALL DRAWINGS ARE SUBJECT TO FURTHER DESIGN DEVELOPMENT AND COORDINATION WITH ENGINEERS INFORMATION.  
 - ALL LIGHTING AND WATERWORKS ARE INDICATIVE AND SUBJECT TO DETAILED DESIGN.  
 - EXISTING HISTORIC BRICK AND STONE FACADES TO BE CLEANED AND RESTORED.  
 - INTERNAL WALLS TO BE STRIPPED OUT, REMOVING 20TH C WORK AND RESTORING ORIGINAL FABRIC.  
 - INDUSTRIAL HERITAGE DETAILS: TRICK BRICK, ELECTRICAL SWITCHES, LIFTING CRANES, ETC. TO BE CLEANED AND RETAINED.  
 - ALL EXISTING ORIGINAL WINDOWS TO BE RETAINED AND RESTORED, WITH NEW HIGH PERFORMANCE SECONDARY GLAZING INSERTED BEHIND.  
 - ALL EXISTING WINDOWS WHICH ARE NOT ORIGINAL TO THE BUILDING TO BE REPLACED WITH HIGH PERFORMANCE WINDOWS TO MATCH EXISTING DESIGN.

**Key**

	Asphalt
	Shared surface paving
	Pedestrian paving
	Car parking bays
	Private amenity space
	Shared soft landscaping
	Children's play area/shared access surface
	Habitat planting
	Trees: Existing & retained
	Removed
	New
	Existing cobbles to be retained & relocated
	Existing cobbles to be retained in situ
	New location of retained cobbles

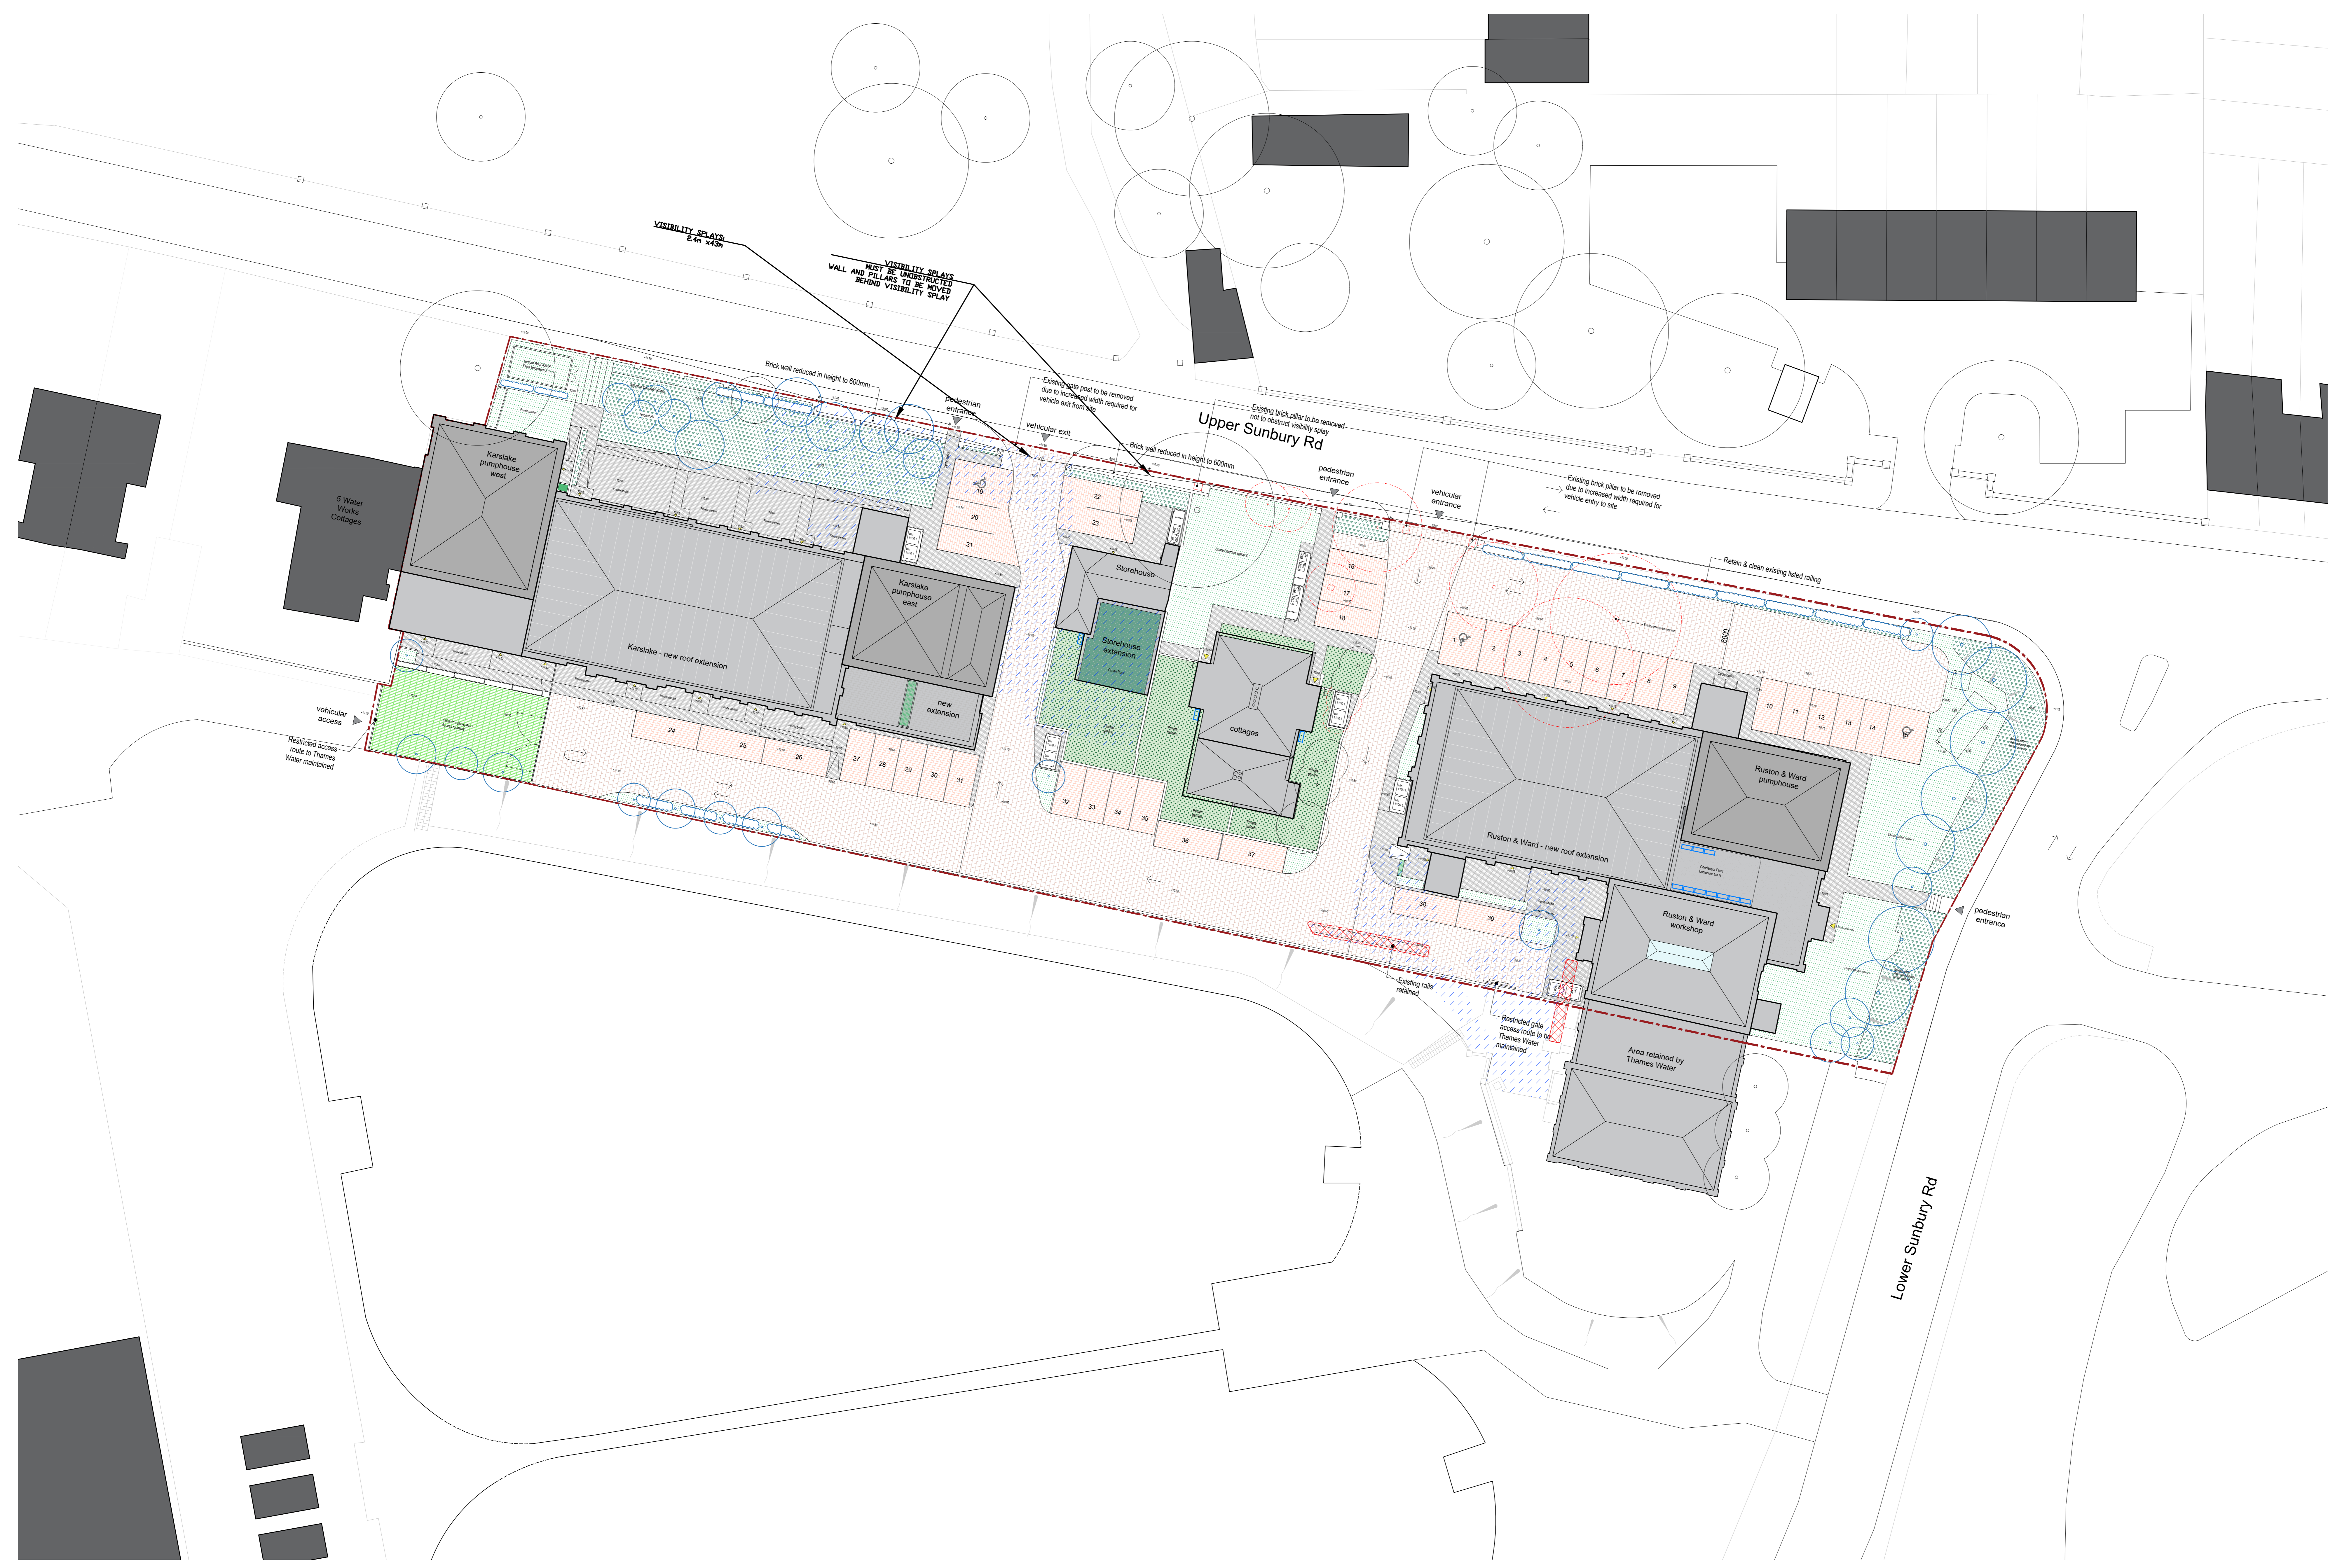

IN PROGRESS

**LOM**  
 client: WATERFALL PLANNING LTD  
 project: HAMPTON WATERWORKS  
 drawing title: PROPOSED SITE PLAN  
 sheet size: A1 scale: 1:200 @ A1  
 status: PLANNING  
 drawing no: 1685-A-P100 revision: J  
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SCALE 1:200  
 Proposed Site Plan

