


PROPOSED FRONT ELEVATION

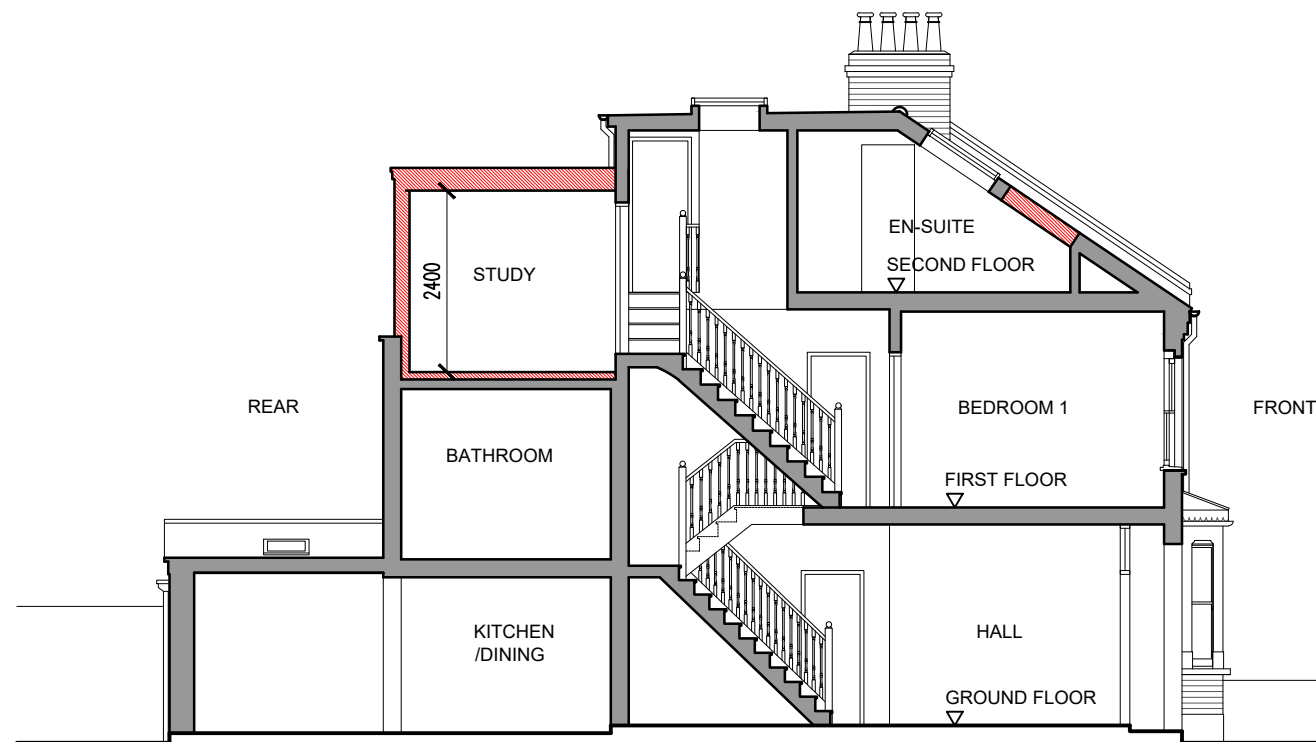

PROPOSED SECTION A

## NOTES

THIS DRAWING IS THE COPYRIGHT OF THE ARCHITECT

### SCHEDULE OF PROPOSED MATERIALS:

**WINDOWS** - UPVC SASHES, DOUBLE GLAZED (COLOUR TO MATCH GROUND FLOOR REAR DOOR)

**DORMER CHEEKS** - SYNTHETIC OR NATURAL SLATE TILES, COLOUR AND SIZE TO MATCH EXISTING

**FLAT ROOF** - DARK GREY WATERPROOFING MEMBRANE

**MAIN ROOF** - SLATE ROOF TO BE REPAIRED/REPLACED TO MATCH EXISTING WHERE NECESSARY

**RAINWATER GOODS** - BLACK UPVC

### VOLUME CALCULATIONS

- EXISTING REAR DORMER EXTENSION

$$V1 = (1/2 A1 \times B1) \times C1$$


$$V1 = (1/2 \ 3.65 \times 2.50) \times 4.45 = \mathbf{20.3 \ m^3}$$

- PROPOSED OUTRIGGER DORMER EXTENSION


$$V2 = (1/2 (B2+B3) \times C2) \times A2$$

$$V2 = (1/2 (2.10 + 2.85) \times 2.60) \times 2.95 = \mathbf{19 \ m^3}$$

**TOTAL VOLUME**  
**V = 39.3 M3**

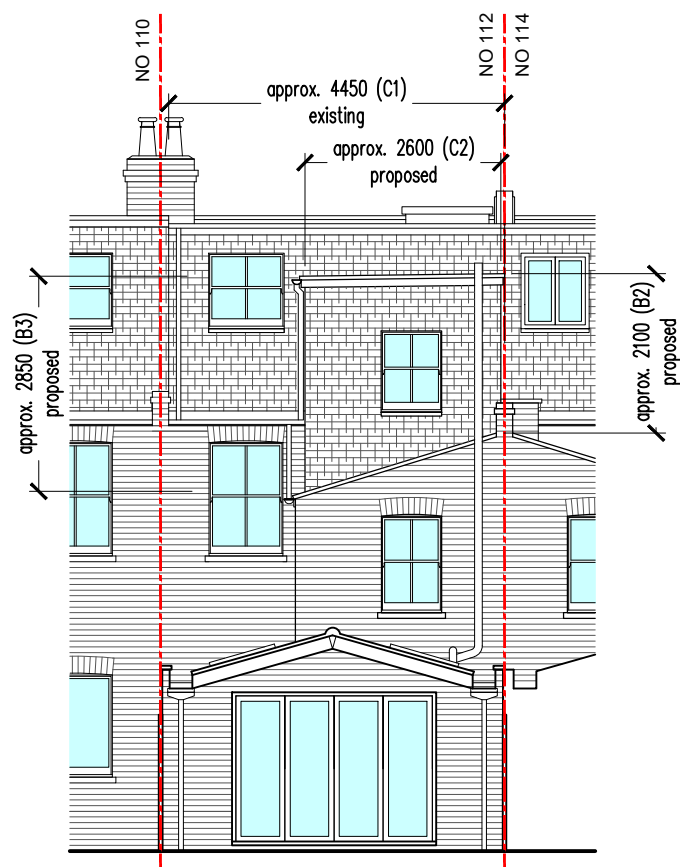

PROPOSED REAR ELEVATION

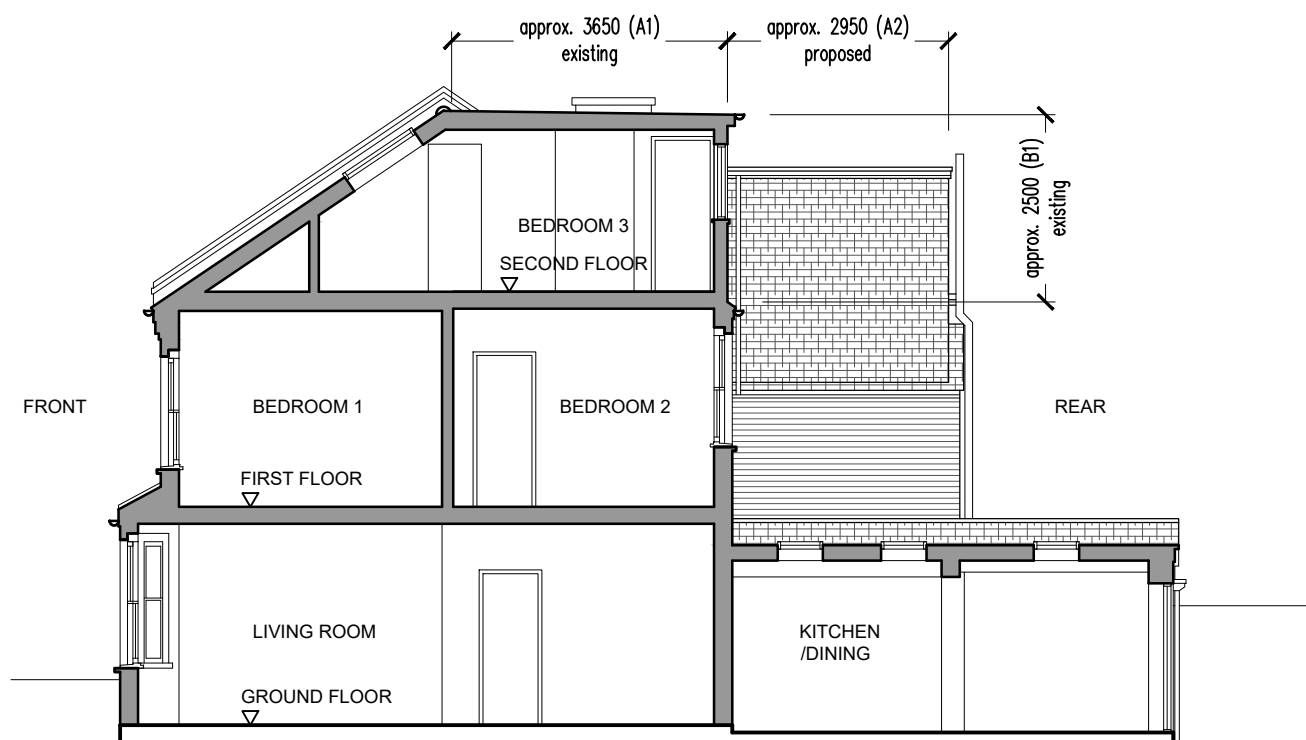

PROPOSED SECTION B AND SIDE ELEVATION

REV DATE DESCRIPTION



PROJECT  
 PROPOSED ERECTION OF A DORMER ROOF EXTENSION TO REAR OUTRIGGER

112 FULWELL ROAD  
 TW11 0RQ TEDDINGTON

DRAWING TITLE  
 PROPOSED ELEVATIONS AND SECTIONS A&B

DRAWING No PL05A SCALE 1:100@A3 DATE APRIL '24

