

	Project Name	Sion Court, Sion Road, Twickenham
	Report Title	Fire Statement – National Requirements
	Description	National Requirements
	Ref. No.	SAV-247151-01-FST-00
	Issue	01
	Revision	00
	Date	23 May 2024
	Prepared by	Sandesh Mohan
	Reviewed by	Helam Chung
	Approved by	Dr Hóng Liáng
-		AESG has prepared this report in accordance with the instructions of their client for their sole and specific use. Any other persons who use any infor

formation contained herein do so at their own risk.



Fire Statement Form

Ар	plication Information		
1.	Site address line 1	Sion Court	
	Site address line 2	Sion Road	
	Site address line 3		
	Town	Twickenham	
	County	Greater London	
	Site postcode (optional)	TW1 3DD	

	-	
2.	Description of proposed development including any change of use (as stated on the application form).	Sion Court is an existing development in Southwest London. The development comprises an existing 'L' shaped residential of the site. At the centre of the site are communal gardens for use by residents. Vehicular garage structures are currently I car parking spaces are located at the around the perimeter of the site and accessed from Lebanon Park and Sion Road existing garage structures and provide 5 new private residential dwellings.
		The proposed design, once complete, will comprise of 2 single level apartments (unit 1 and 5) and 3 houses of ground +1 the East end of the proposed block will be designed for assisted living, accommodating occupants such as wheelchair user
		The height (as measured from the fire service access level to the highest occupied floor) of units 1 and 5 is approximately the fire service access level to the highest occupied floor) of units 2, 3 and 4 are approximately 6 meters. The area of the
		In order to protect the means of escape, each unit will include either a protected entrance hall or protected stair enclose within the units. This design is compliant with the requirements of BS 9991.
		As part of the works, it is intended that the communal amenity space will be updated and refurbished as well as undertag ardens for the new properties. The roof area across the entire block will be designed as a flat green roof space.
		An area is designated at front garden of every unit for daily refuse and recycling collection. Cycles stores with louvred, lo the site.
		Inset balconies will be provided to Unit 2, 3 and 4 on the first floor, overlooking the communal garden. As a balcony is materials used will conform to requirements of BS 9991 for external fire spread.

al building, located in the Southwest corner y located at the North of the site. Additional bad. The scheme proposes to demolish the

+1 floor (unit 2, 3 and 4). Unit 5, located at sers.

ely 3 meters. The height (as measured from he largest units is $77m^2$.

osure which separates the habitable rooms

ertaking some landscaping to create private

lockable doors are proposed on the East of

is a specified attachment, the design and

3.	Name of person completing the fire statement (as per section 15, relevant qualifications	This report has been signed off by Dr Hóng Liáng, Director of AESG UK Fire Engineering Division. A summary of Dr Hodisplayed in the table below; Qualifications / Experience based (minimum requirements)		
	and experience. Guide: no more than	Chartered engineer?	No	
	200 words	Member of Institute of Fire Engineers?	Yes - (AIFireE)	
		Fire engineering experience?	Yes – 19 years	
		Qualifications / Experience based (Additional)		
		Qualification 1	BSc, Civil Engineering	
		Qualification 2	MSc, Structural Engineering	
		Qualification 3	PhD, Structural and Fire Safety Engine	

	4.	State what, if any, consultation has been undertaken on issues relating to the fire safety of the development; and what account has been taken of this. Guide: no more than 200 words	 AESG have conducted a fire and life safety review of the proposed design. The review has been undertaken using the 9991:2015 for the proposed development and Approved Document B (ADB) Volume 1 (2019 edition incorporating for the proposed rooflights and turning facilities for fire appliances. The purpose of the review was to ensure that the constrained which is suitable and sufficient for the building use and occupancy. The main considerations were based on the requirement B1 Means of warning and escape B2 Internal fire spread (linings) B3 Internal fire spread (structure) B4 External fire spread
			B5 Access and facilities for the fire service
			The review has established if the proposals would comply with the functional requirements of Part B – Schedule 1 of the B 2018, 2022 and 2024) using the standard guidance of BS 9991, ADB. If any fire engineered solutions are required in or criteria for the building in the future design, PD 7974 will be referred to.
			Based on the findings of the review AESG have concluded that the new elements of the building have been designed i existing fire safety provisions remain sufficient for the risks associated with the building.

long	qualification	and	experience	has	been
leerin	Ig				

the guidance detailed in **British Standard** ing 2020, 2022 and 2024 amendments) e design can support a robust fire strategy, nent in the current Building Regulation 2010;

e Building Regulations 2010 (as amended in order to achieve the minimum performance

d in a code compliant manner and that the

\bigcirc

with the application.

Site layout plan with block numbering as per building schedule referred to in 6 5. Plans must be consistent with other plans drawings and information submitted in connection Tick one: Provided as a separate plan V (See Appendix A) V (See Appendix A)

The principles, concepts and approach relating to fire safety that have been applied to the development. Where instructed to do so you must select one of the options in the relevant section of the Table at the end of this Form.

6. **Building Schedule Building information** Site information Resident g) a) b) c) d) e) f) h) • Proposed Balconies • Block no. as Block height Location of • Standards • External wall Approac use (one use within relating to systems per site plan (m) evacuat layout per line) block by fire safety / • Number of floor level approach storeys applied excluding basements Number of stories including basements A single block Residential All Floors BS 9991 Worse than Class Worse than Class Stay Put Unit Height comprising 5 Flats A2-s1, d0 A2-s1, d0 Note: Occu Ground independent only in the 1 & 5 (The building is (The building is Floor units. fire origin v below 18m and below 18m and as Only evacuate. such, BS as such, BS 2,3&4 3m 9991/ADB does 9991/ADB does Note: Evac not place not place from the gi • Unit 1 & 5 restrictions on restrictions on the floor entrar Ground only the materials materials used in hall or through used in specified external wall) the window • Unit 2,3 & 4 evacuation attachments) Ground +1through the balconies o 2,3 & 4

Sion Court, Sion Road, Twickenham Fire Statement – National Requirements

Inserted into form

: safety	safety information					
ch to tion	i) • Automatic suppression	j)Accessible housing provided				
upants flat of will cuation round nce ough vs or n e inset of unit	Not provided (In accordance with BS 9991, an automatic suppression system is not required to be incorporated into the design)	Yes, in Unit 1.				



Sp	ecific technical comple	xities
7.	Explain any specific technical complexities in terms of fire safety (for example green walls) and/or departures from information	All units are entered directly from outside the building at ground level. As such, means of escape for each unit will be BS9991 and treated as houses. Unit 1 is designed to accommodate assisted living. It is understood that occupants who reside within this unit are capable of may still require the use of walking frames, wheelchairs, etc., in order to escape. To facilitate an effective egress s accommodate these requirements. In addition, escape routes will be situated on level ground or be provided with suitabl 1:12.
	Guide: no more than 500 words	The proposed design accommodates green roof to increase the biodiversity and water attenuation reducing peak run off d be constructed in accordance with 'Fire Performance of Green Roofs and Walls' by Department of Communities and Loo provision of non-vegetated border zones or fire breaks in specific areas such as around all openings/ rooflights in roofs, across roofs to limit the area of the green roof. If any non- compliant issues occur during the design development, suitable robust fire engineering design will be applied

	Iss	ssues which might affect the fire safety of the development				
	8.	Explain how any issues which might affect the	The Fire and Rescue Services can access the site using existing roadways. The building can be accessed form Entrance A: Road where a fire appliance can be sited on the existing roadway in order to lay down the hose.			
development have been occupants residing in Unit 1. All other vehicles are restricted from enter		development have been	Sion court has car parking available at the south periphery along Sion Road. A single car parking space, located in the occupants residing in Unit 1. All other vehicles are restricted from entering the internal areas of the site by a fold down be provided with an unlocking mechanism which will not cause delay to the Fire Service entering the site. A strategy for suit			
		Guide: no more than	in RIBA Stage 2.			
		500 words	The Fire Service can park a pumping appliance in positions within the site so that all areas within each unit is accessible wit for laying hose). This is compliant with the requirements of BS 9991.			

Lo	ocal development document policies relating to fire safety					
9.	Explain how any policies relating to fire safety in relevant local development documents have been considered.	There are no local development documents which have been provided for consideration in matters relating to fire safety.				
	Guide: no more than 500 words					

be designed in accordance with Section 6 of

e of independent escape. However, occupants s strategy, door widths will be increased to able ramping with a gradient no greater than

f during heavy rainfall. The green roof should ocal Government. It recommends either the fs, around vertical elements and at intervals

ed.

A: Lebanon Park Road and Entrance B: Sion

the North-West of the site is provided for bollard at Entrance A and B. Bollards will be suitable security measures will be developed

vithin 45m (measured along a route suitable

y.



Fire	Service Site Plan	
10.	Explanation of fire service site plan(s) provided in 14. including what guidance documents have informed the proposed arrangements for fire service access and facilities?	The site plans (Section 14) show vehicle tracking routes for Fire Service appliances. The Fire and Rescue Service can access the site using existing roadways (See Section 11). The building can be accessed Entrance 2: Sion Road where a fire appliance can be sited at either of the entrances in order to lay down the hose. The Fire Service can park a pumping appliance in positions within the site so that all areas within each unit is access suitable for laying hose). This is compliant with the requirements of BS 9991. An evacuation assembly point is located in the South-West corner of the site adjacent to the existing residential block. Of using a levelled pedestrian pathway visible from all the residential units in the scheme. Ramps, if any, provided on the more than 1 in 12. An assembly point in this location will not obstruct firefighting operations.
	Guide: no more than 200 words	Fire Service pumping appliances can gain access to water supplies using the existing hydrant network. This network is and the fire service. Existing hydrants are located on both Lebanon Park Road and Sion Road.
		As the units are below 18m in height no additional firefighting facilities have been provided, nor are they required for c

Eme	ergency road vehicle a	ccess	
11.	Specify emergency road vehicle access to the site entrances indicated on the site plan	The site can be accessed from 2 separate entrances. Entrance 1 is located on Le Sion Road at the South-East corner of the site. As Lebanon Park Road and Sion P to assume that they meet the criteria for width and weight criteria set out within existing roadways. The site includes an open-air carpark only for Unit 1.	Road are existing roadways within an es
	Guide: no more than 200 words	Car parking spaces are provided along the South and West perimeter of the site. Parking bays will be marked so that ve routes into the development. A single disabled car parking space is located within the development. It is located at the N	
		All other vehicles are restricted from entering the internal areas of the site by a f mechanism which will not cause delay to the Fire Service entering the site. A stra	
	Is the emergency vehicle tracking route within the site to the siting points for appliances clear and	Tick one:	
		Yes	
	unobstructed?	\checkmark	

sed form Entrance 1: Lebanon Park Road and

cessible within 45m (measured along a route

Occupants can move away from their demise ne escape routes should have a gradient of no

is tested and maintained by the water board

compliance with BS 9991.

corner of the site. Entrance 2 is located on established residential area, it is reasonable rvice vehicles can access the site from these

vehicles do not obstruct Fire Service access North-West corner adjacent to Unit 5.

. Bollards will be provided with an unlocking vill be developed in RIBA Stage 2.

No

Sitin	Siting of fire appliances		
	information on which fire service appliances are	The 2 main vehicles used by the Fire Service are pumping appliances and high-reach appliances. Pumping appliances ca building is below 9m it is not anticipated that the predetermined attendance will include a high-reach appliance. The weight carrying capacity (12.5 tonnes) and width measurements (3.7 metres) are assumed to be suitable.	
	accommodated by the site	As the emergency assembly point is located at the south-west corner of the site, emergency services such as the Am Lebanon Park and Sion Road entrances to the assembly point. This will allow occupants who may require medical att	
	Guide: no more than 200 words	impacting on firefighting operations.	


Siti	ng of fire appliances	ices			
13. Suitability of water supply for the scale of development proposed Fire service pumping appliances have a water tank which ca the fire whilst firefighters connect to a supplementary water in firefighting operations. Typically, fire hydrants in London of and type of building.			pplementary water source. Hydrants loo	cated on Lebanon Park Road and Sion R	oad will provide additional water for use
	Guide: no more than 200 words				
		Tick one: Nature of water supply			
		Open water - limited		Open water - unlimited	
		Hydrant - public	\checkmark	Hydrant - private	
		Tank supply			
		Tick one:			
		Does the proposed of	development rely on existing hyd	rants and if so, are they currentl	y usable / operable?
		Ye	s		
		N	0		
		Don't	know		\checkmark

Fire service site plan

carry 9 metre and 13.5 metre ladders. As the he access roads are both existing and so the

mbulance Service can gain access from both attention to be assessed and treated without

\bigcirc

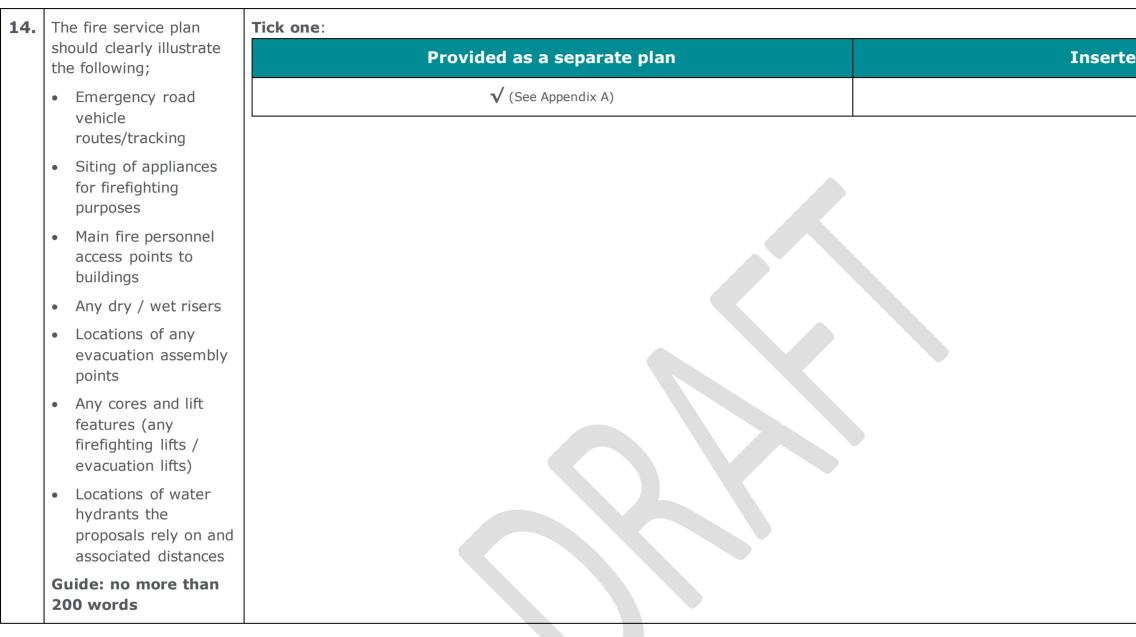

Fire statement completed by						
15.	Signature	Pier				

16.	Date	23 May 2024
-----	------	-------------

Sion Court, Sion Road, Twickenham Fire Statement – National Requirements

Inserted into form



Table for completion of Box 6

Tables below highlight the key elements of the building and fire safety packages incorporated within the design.

A. Purpose use			
hoose 1 of the following per line for box 6			
Residential flats, maisonettes, studios	Hotel	Hospital	
Residential houses	Shop	School	
Residential bedsits, cluster flats	Restaurant, café, hot food take-away, drinking establishment	Community use, childe	
Supported accommodation	Office, research and development	Prison, detention cent	
Student accommodation	Industrial, storage or distribution	Car parking	
Serviced apartments	Care home	Service area	
Other residential accommodation	Health care	Flexible use	

A. Standards relating to fire safety/ approach applied (including to external wall systems)		
Choose 1 of the following per line for box	noose 1 of the following per line for box 6	
Approved Document B vol 1	BS 9999	HTM0502
BS 9991	Fire engineered approach	BS 7974
Approved Document B vol 2	BB100	

6fA. Balconies					
Choose 1 of the following per line for box 6	oose 1 of the following per line for box 6				
No balconies	Class A2- s1, d0 or better	Worse than Class A2-s			

Sion Court, Sion Road, Twickenham Fire Statement – National Requirements

ldcare (not school)
ntre
2-s1, d0



6gA. External wall systems			
Choose 1 of the following per line for box 6			
Class A2- s1, d0 or better	Worse than Class A2-s, d0		
		·	
6hA. Approach to evacuation			
Choose 1 of the following per line for box 6			
Simultaneous	Staged	Progressive horizont	

Phased	Stay put	Delayed	
6iA. Automatic suppression			
Choose 1 of the following per line for box 6	Choose 1 of the following per line for box 6		
Yes- residential sprinklers, full	Yes- commercial sprinklers, full	Yes- other	
Yes- residential sprinklers, partial	Yes- commercial sprinklers, partial	Not provided	

	6jA. Accessible housing provided			
Choose 1 of the following per line for box 6				
	None	M4(2) & M4(3)	N/A non-residential	
	M4(2)	M4(3)		

al	





APPENDIX A

FIRE STRATEGY DRAWINGS

Sion Court, Sion Road, Twickenham Fire Statement – National Requirements



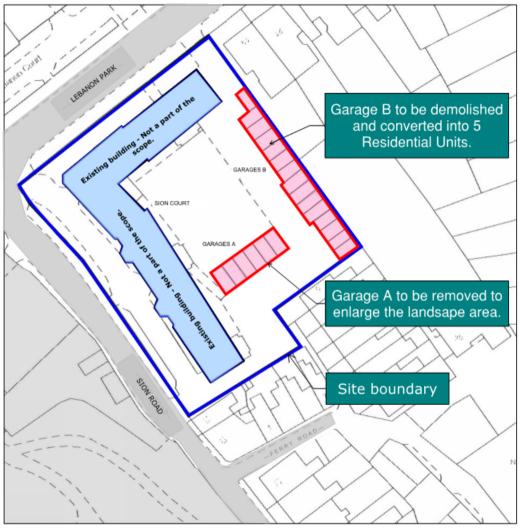

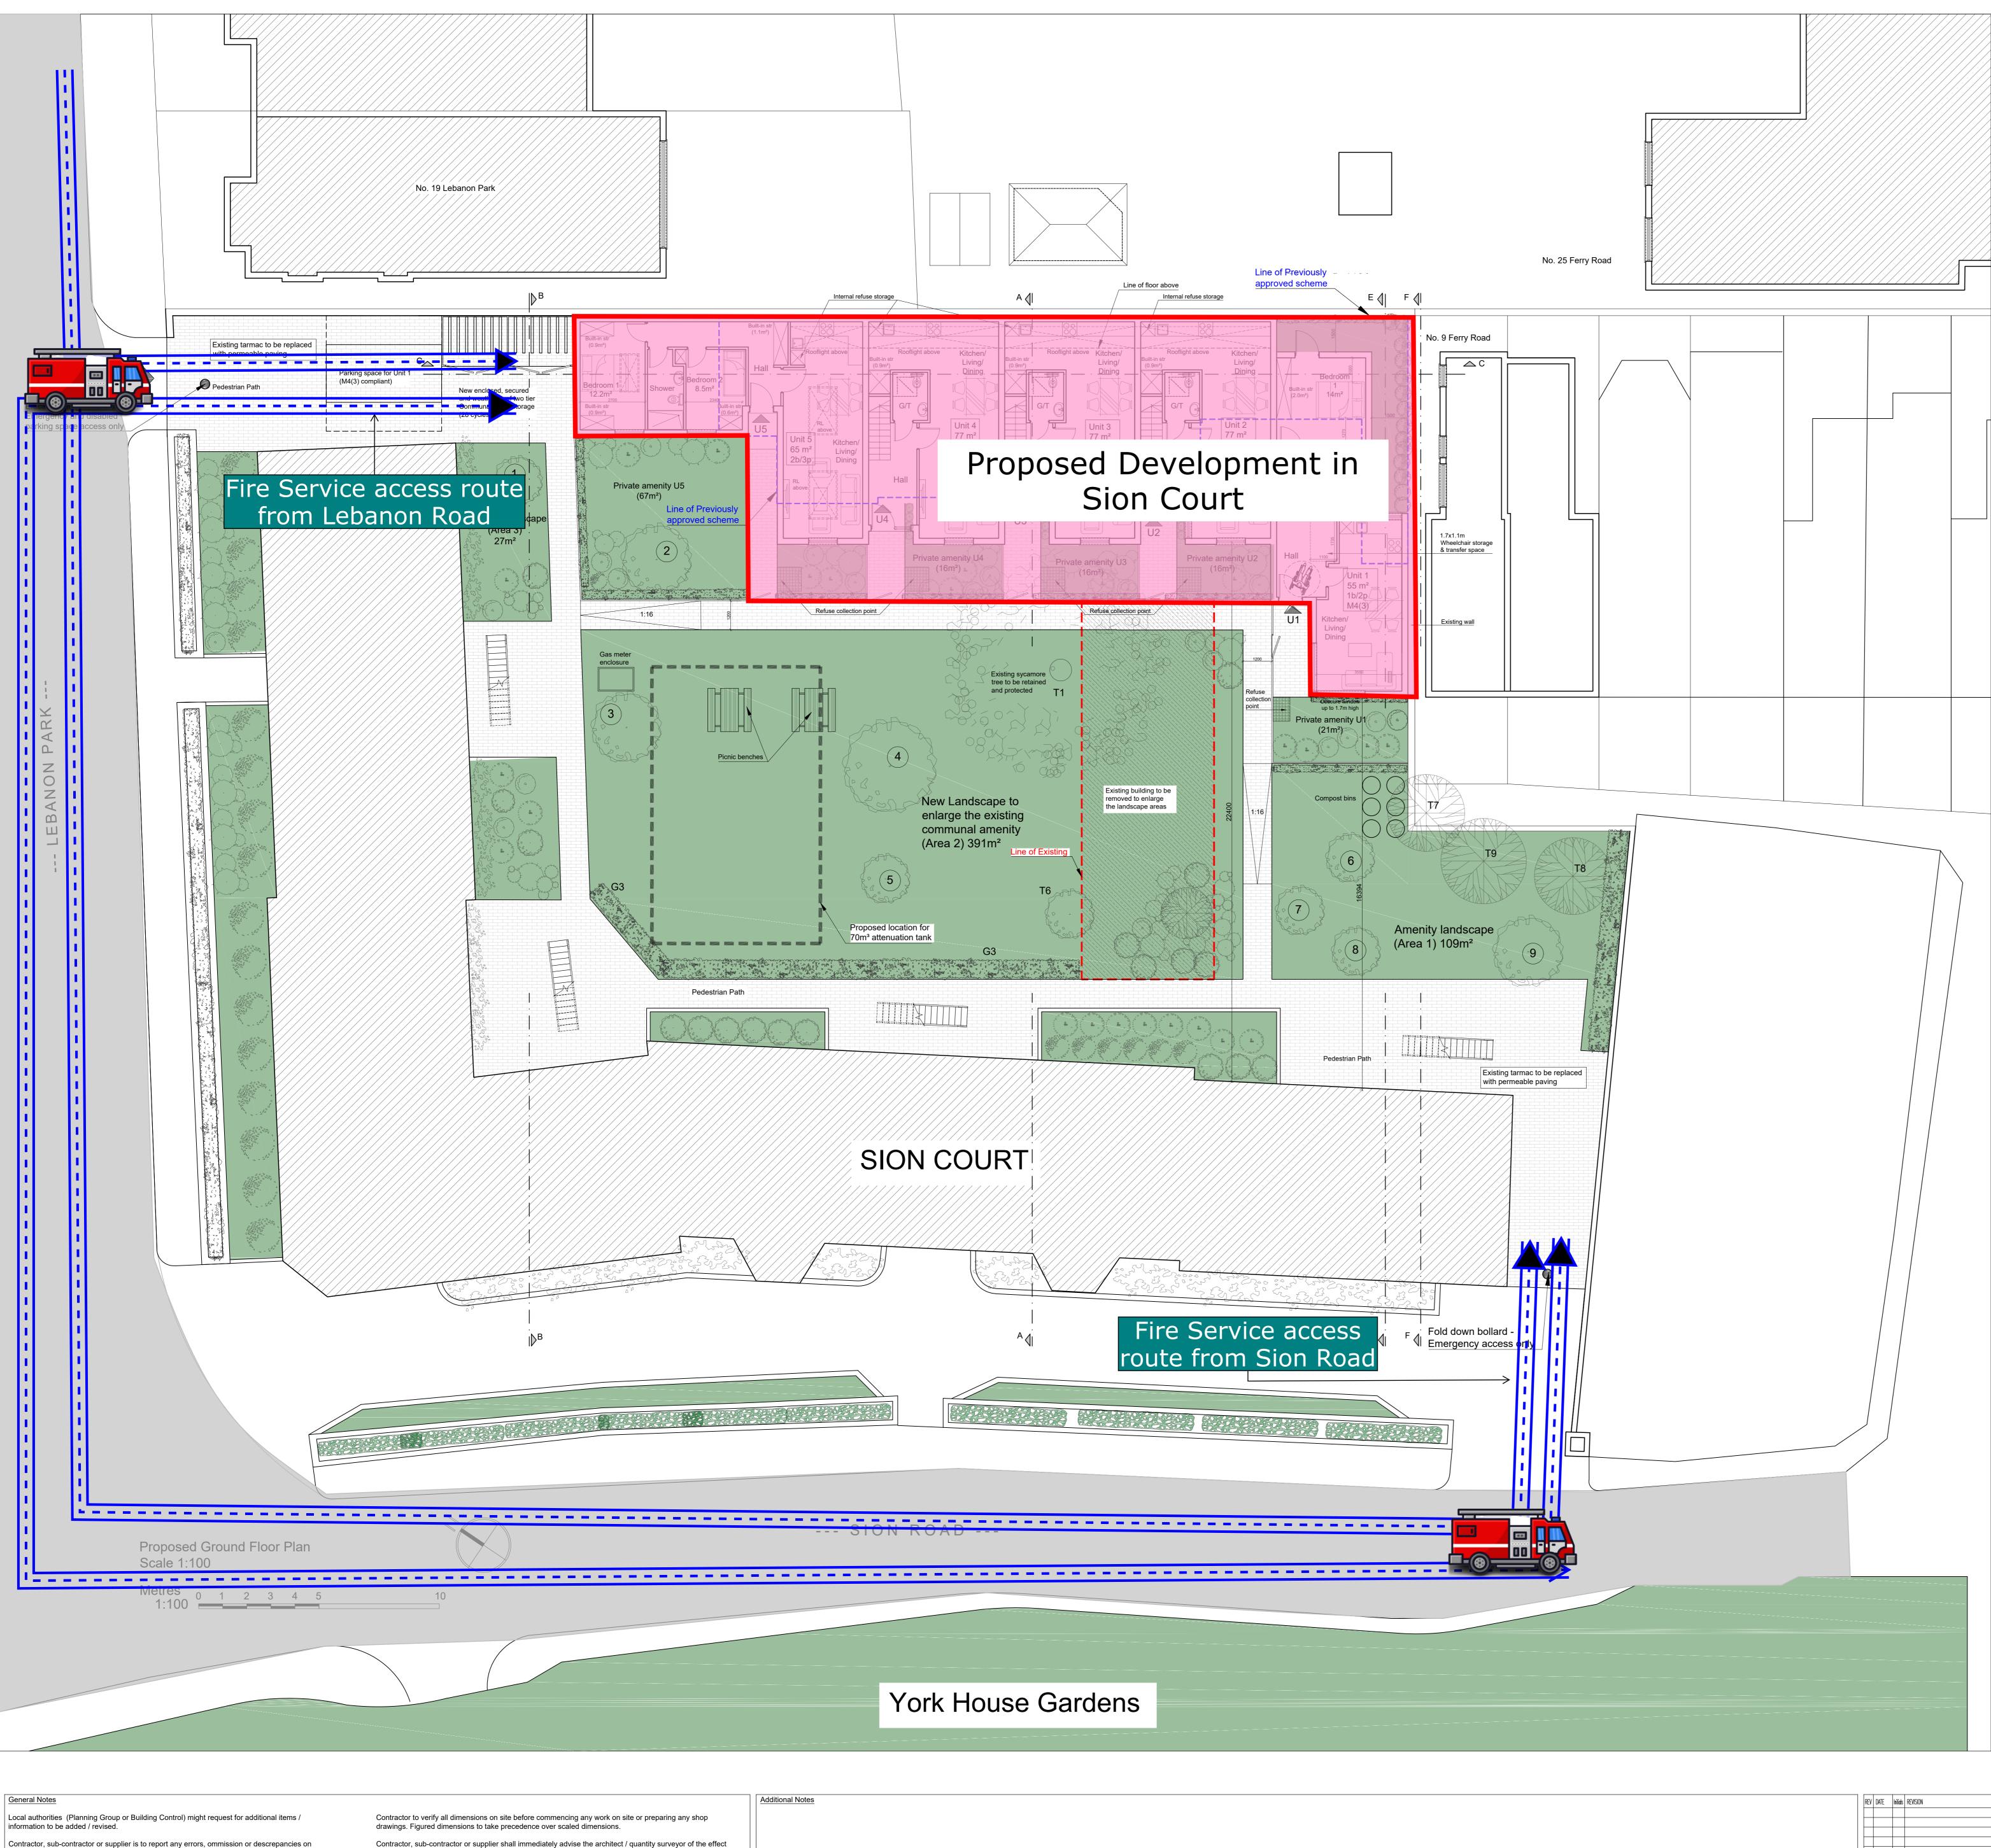

Contractor, sub-contractor or supplier is to report any errors, ommission or descrepancies on the drawings, and shall not vary any work shown on the drawings without obtaining prior approval from the architect. Contractor, sub-contractor or supplier is responsible for requesting any additional information from the architect for the correct execution of the works. Contractor, sub-contractor or supplier shall supply to the architect all shop drawings, illustrations, specifications, etc. of all specialist work to be incorporated into the main contract

works, and shall immediately inform the architect if any work shown on this drawing is not in

industry or if it does not comply with the relevant local authority bye-laws or building regulations.

accordance with the relevant codes of practice recognised as good practice throughout the

Contractor to verify all dimensions on site before commencing any work on site or preparing any shop drawings. Figured dimensions to take precedence over scaled dimensions.
Contractor, sub-contractor or supplier shall immediately advise the architect / quantity surveyor of the effer upon programme and cost of any alterations to the proposed works shown on this drawing.
All materials, components and workmanship to comply with the relevant British Standarts, Codes of Pract and appropriate manufacturers' recommendations that from time to time shall apply.
This drawing superseeds all previous issues of the same drawing number with earlier revisions.
This drawing and design is copyright of Tal Arc Ltd and remains the property of Tal Arc Ltd, and as such the contents must not be disclosed to anyone or reproduced in any way without prior written consent.

	Additional Notes
fect	
ctice	
n the	
i uic	

	No. of bedrooms / persons
Unit 1	1b2p
Unit 2	2b3p (2storey)
Unit 3	2b3p (2storey)
Unit 4	1b2p (2storey)
Unit 5	2b3p

Amenity Landscape 1 (r
Amenity Landscape 2 (r
Amenity Landscape 3 (r
TOTAL (m
Private Amenity Landscape (r
Green Roofs (r

The existing Amenity Landscape is 334m². The proposal adds Communal amenity landscape of **193m²** New Communal Amenity Lansdcape area is a **Total of 527m²**. Total Landscape area (including Private amenity landscape and Green roofs) is **818m²**.

WASTE MANAGEM
The existing Site ma servicing activity and proposed residential
Each of the residenti
Refuse collection at t will extend the currer Court to the propose
As part of the manag front garden of each building at Lebanon (

arrangement.

NEW TREE PLANTI
1. Thorn, Crataegus
(2) Crab apple, Malus
(3) Tibetan cherry, Pro
(4) Golden rain tree, k
(5) Flowering cherry, I
(6) (7) (8) Birch, Betula
(9) Amelanchier Balle

REV	DATE	Initials	REVISION	PROJECT
				New Residential Units at
				Sion Court
				Twickenham, TW1 3DD
\vdash				
\vdash				
				CLIENT
				Moreland Residential (UK
\vdash				
\vdash				

	Minimum Gross Internal Areas (GIA) and Storage						
; /	Min. London Plan flat area (m²)	Proposed flat area (m²)	Proposed private amenity (m²)	Proposed built-in storage (m²)			
	50m² (1 storey)	55.6m²	39m²	2.1m²			
	70m² (2 storey)	77m²	21.5m²	3.62m²			
	70m² (2 storey)	77m²	21.5m²	3.62m²			
	58m² (2 storey)	71.8m²	21.5m ²	2.22m²			
	61m² (1 storey)	65m²	67m²	2.69m²			

A	menity Landscape Are	eas
Existing	Proposed	Added
CON	IMUNAL FOR ALL RESI	DENTS
34	109	75
300	391	91
-	27	27
334	527	193
	PRIVATE	
-	100	100
	GREEN ROOFS	
-	191	191
	Existing CON 34 300 -	COMMUNAL FOR ALL RESII 34 109 300 391 - 27 334 527 PRIVATE 100 GREEN ROOFS GREEN ROOFS

MENT PLAN

akes use of on-street servicing opportunities for all delivery and nd refuse collections. The proposals will retain the same strategy for the al units.

tial units will be provided with internal refuse storage.

t the Site will be administered by on-site management personnel, who rent waste management arrangement for the existing 36 units at Sion sed units.

agement regime, refuse and recycling will be collected daily from the ch proposed unit to an allocated refuse storage point in the neighbouring n Court. Both buildings have the same managing agents and the same

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s prunifolia Splendens, 12-14cm, 65litre

us hupehensis, 12-14cm, 45litre

Prunus serrula Tibetica, 12-14cm, 45litre


, Koelruteria paniculata 20-25cm, 250litre.

Prunus pandora 12-14cm, 45litre

ula albosinensis Fascination,14-16cm, 65 litre

(9) Amelanchier Ballerina, 10-12cm, 45litre

1					
ZONE	DISCIPLINE ARCHITECT	TURE	status PLANNING	TAL ARC LTD.	
LEVEL A	DRAWING NUM	1BER	REVISION	ARCHITECTURE DESIGN	
PAPER SIZE	A0 SHEET			2a Crescent Road London N3 1HP, U.K.	
				T. 020 3719 0793	1
DRAWING TI	TLE Proposed G	Fround Flo	or Plan	E. INFO@TALARC.CO.UK W. www.talarc.co.uk	
SCALE 1:100	DATE 08/04/2024	DRAWN YS	CHECKED YS	PROJECT TITLE New Residential Unit	s at Sion Court

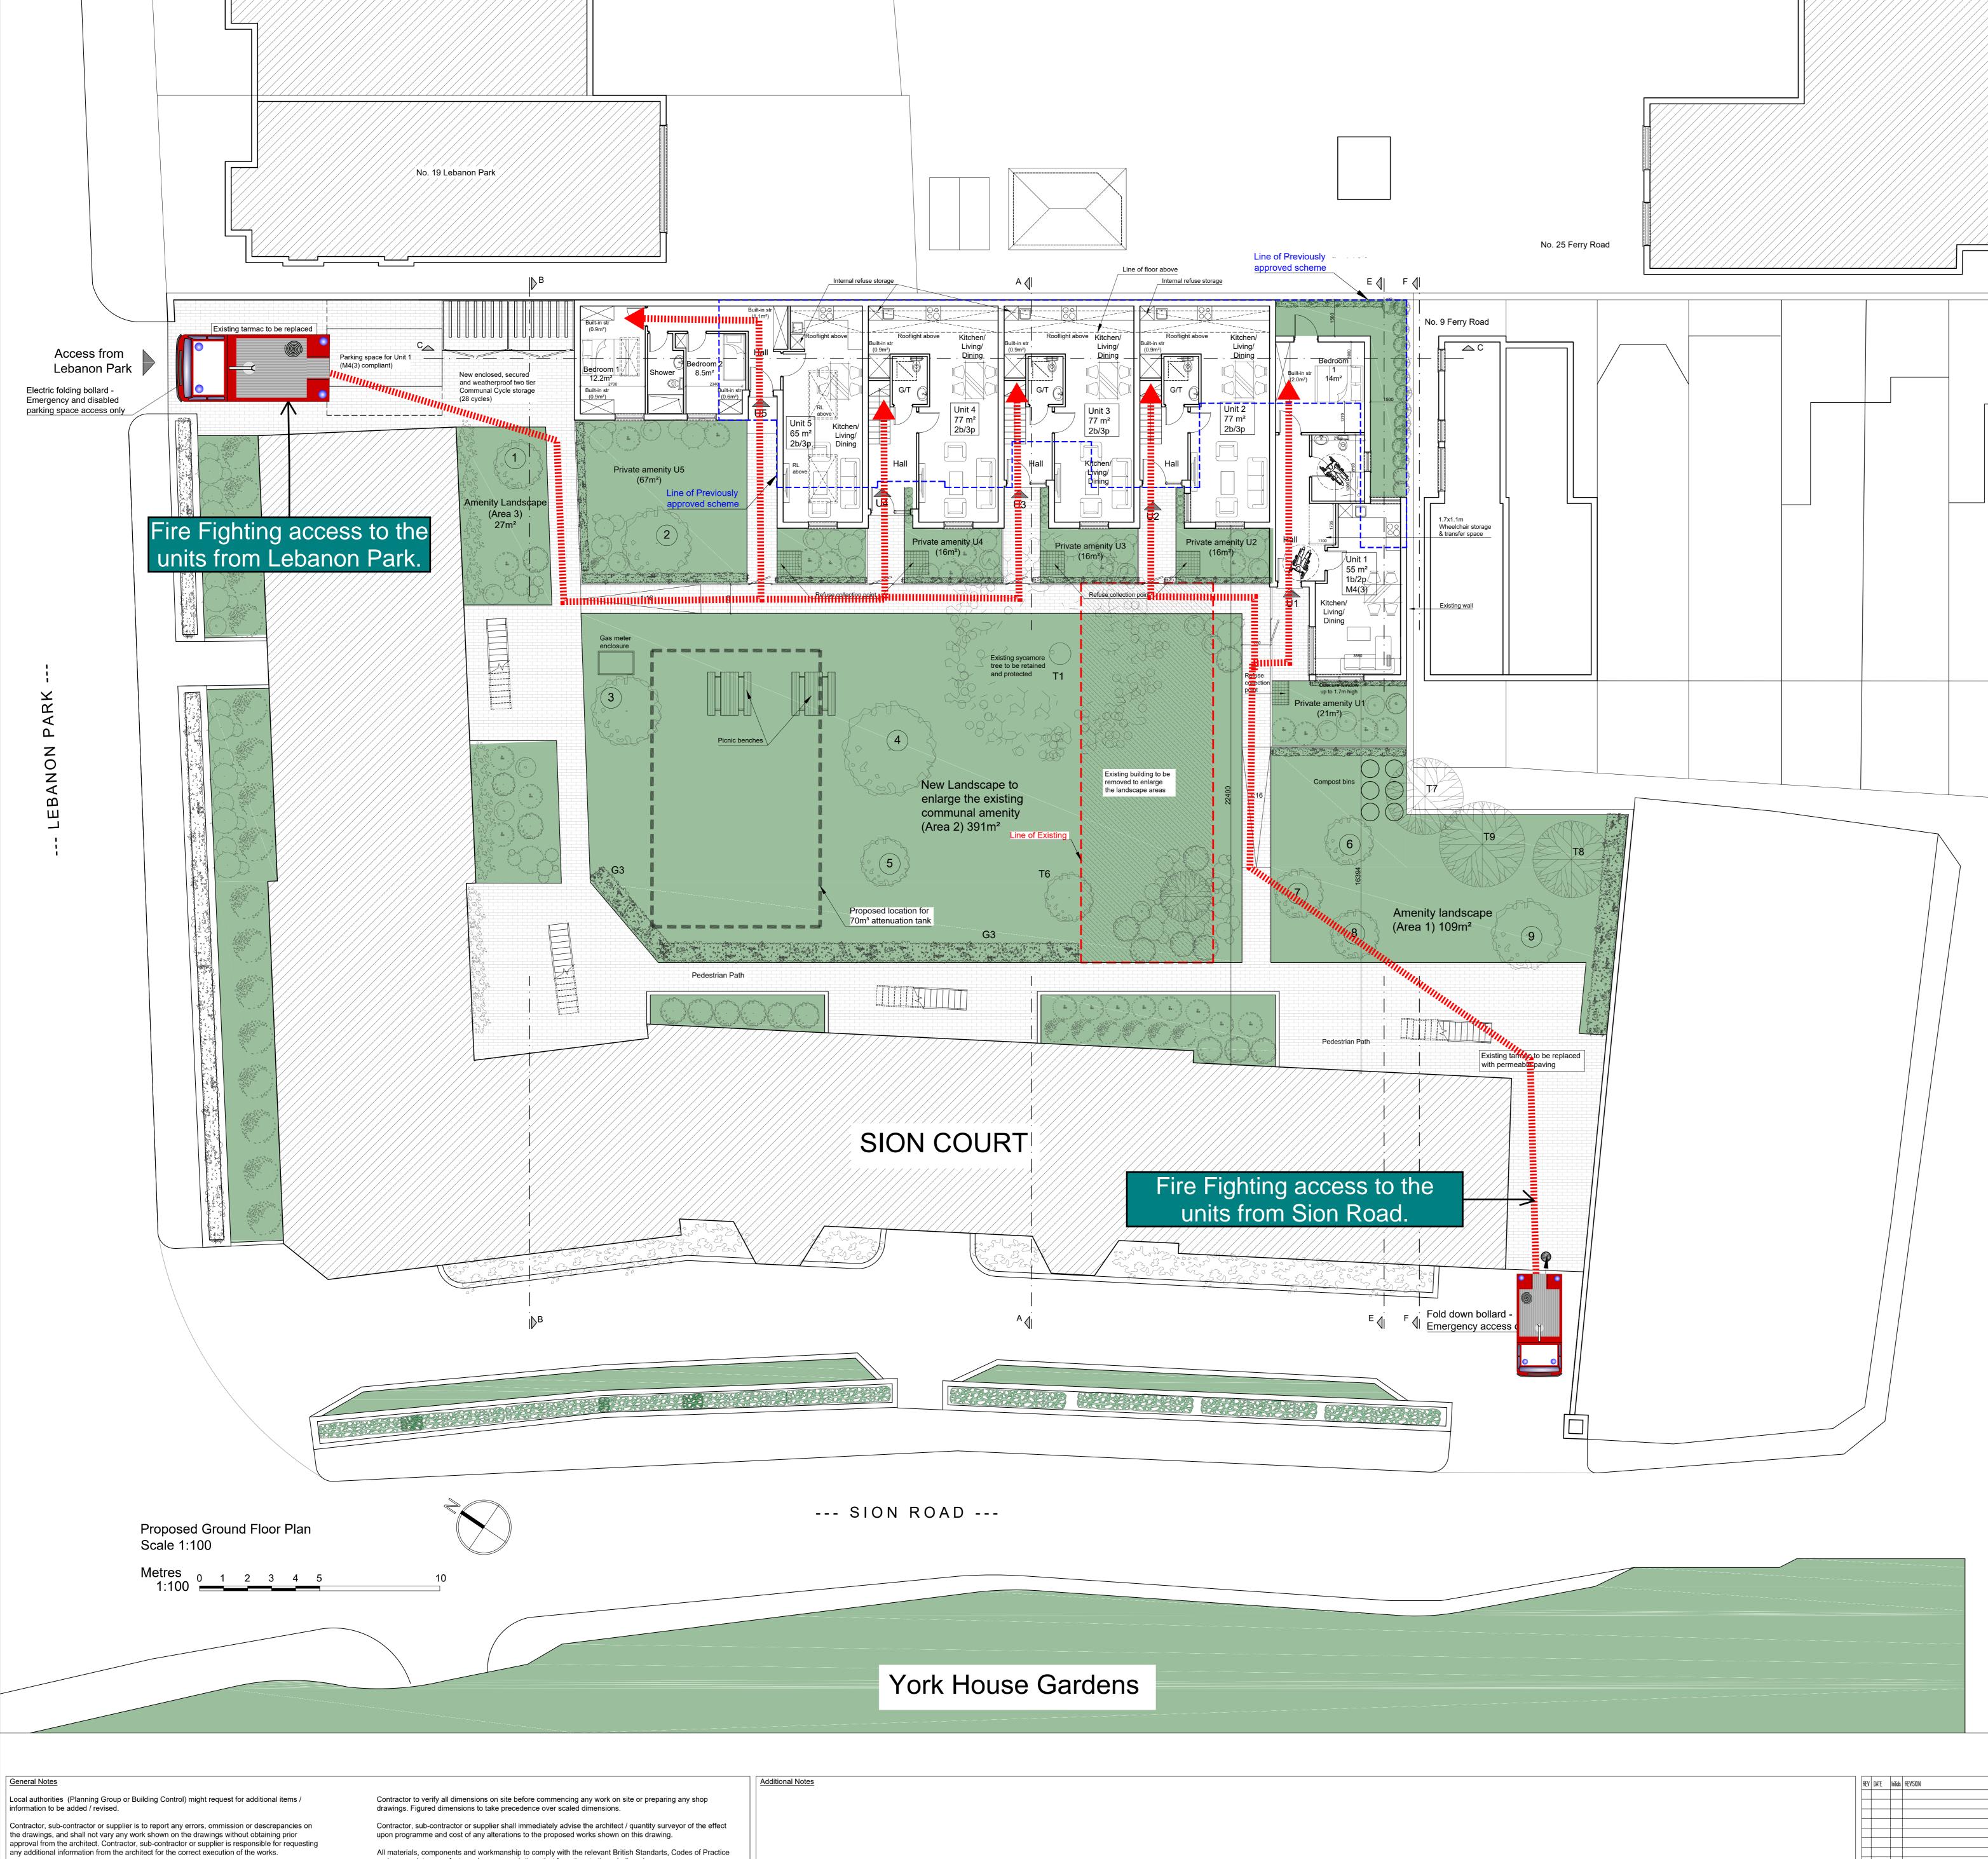

Contractor, sub-contractor or supplier shall supply to the architect all shop drawings, illustrations, specifications, etc. of all specialist work to be incorporated into the main contract works, and shall immediately inform the architect if any work shown on this drawing is not in accordance with the relevant codes of practice recognised as good practice throughout the

industry or if it does not comply with the relevant local authority bye-laws or building regulations.

and appropriate manufacturers' recommendations that from time to time shall apply. This drawing superseeds all previous issues of the same drawing number with earlier revisions. This drawing and design is copyright of Tal Arc Ltd and remains the property of Tal Arc Ltd, and as such the contents must not be disclosed to anyone or reproduced in any way without prior written consent.

	Minimum Gross Internal Areas (GIA) and Storage					
	No. of bedrooms / persons	Min. London Plan flat area (m²)	Proposed flat area (m²)	Proposed private amenity (m²)	Proposed built-in storage (m²)	
Unit 1	1b2p	50m² (1 storey)	55.6m²	39m²	2.1m²	
Unit 2	2b3p (2storey)	70m² (2 storey)	77m²	21.5m²	3.62m ²	
Unit 3	2b3p (2storey)	70m² (2 storey)	77m²	21.5m²	3.62m ²	
Unit 4	1b2p (2storey)	58m² (2 storey)	71.8m²	21.5m²	2.22m ²	
Unit 5	2b3p	61m² (1 storey)	65m²	67m²	2.69m²	

	Amenity Landscape Areas			
	Existing	Proposed	Added	
	COMMUNAL FOR ALL RESIDENTS			
Amenity Landscape 1 (m²)	34 109 75			
Amenity Landscape 2 (m²)	300	391	91	
Amenity Landscape 3 (m²)	-	27	27	
TOTAL (m²)	334	527	193	
	PRIVATE			
rivate Amenity Landscape (m²)	-	100	100	
	GREEN ROOFS			
Green Roofs (m ²)	-	191	191	

The existing Amenity Landscape is 334m². The proposal adds Communal amenity landscape of <u>193m²</u> New Communal Amenity Lansdcape area is a <u>Total of 527m²</u>. Total Landscape area (including Private amenity landscape and Green roofs) is <u>818m²</u>.

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]	REV	DATE	Initials	REVISION	PROJECT
					New Residential Units at Sion Court Twickenham, TW1 3DD
					CLIENT Moreland Residential (UK

MENT PLAN

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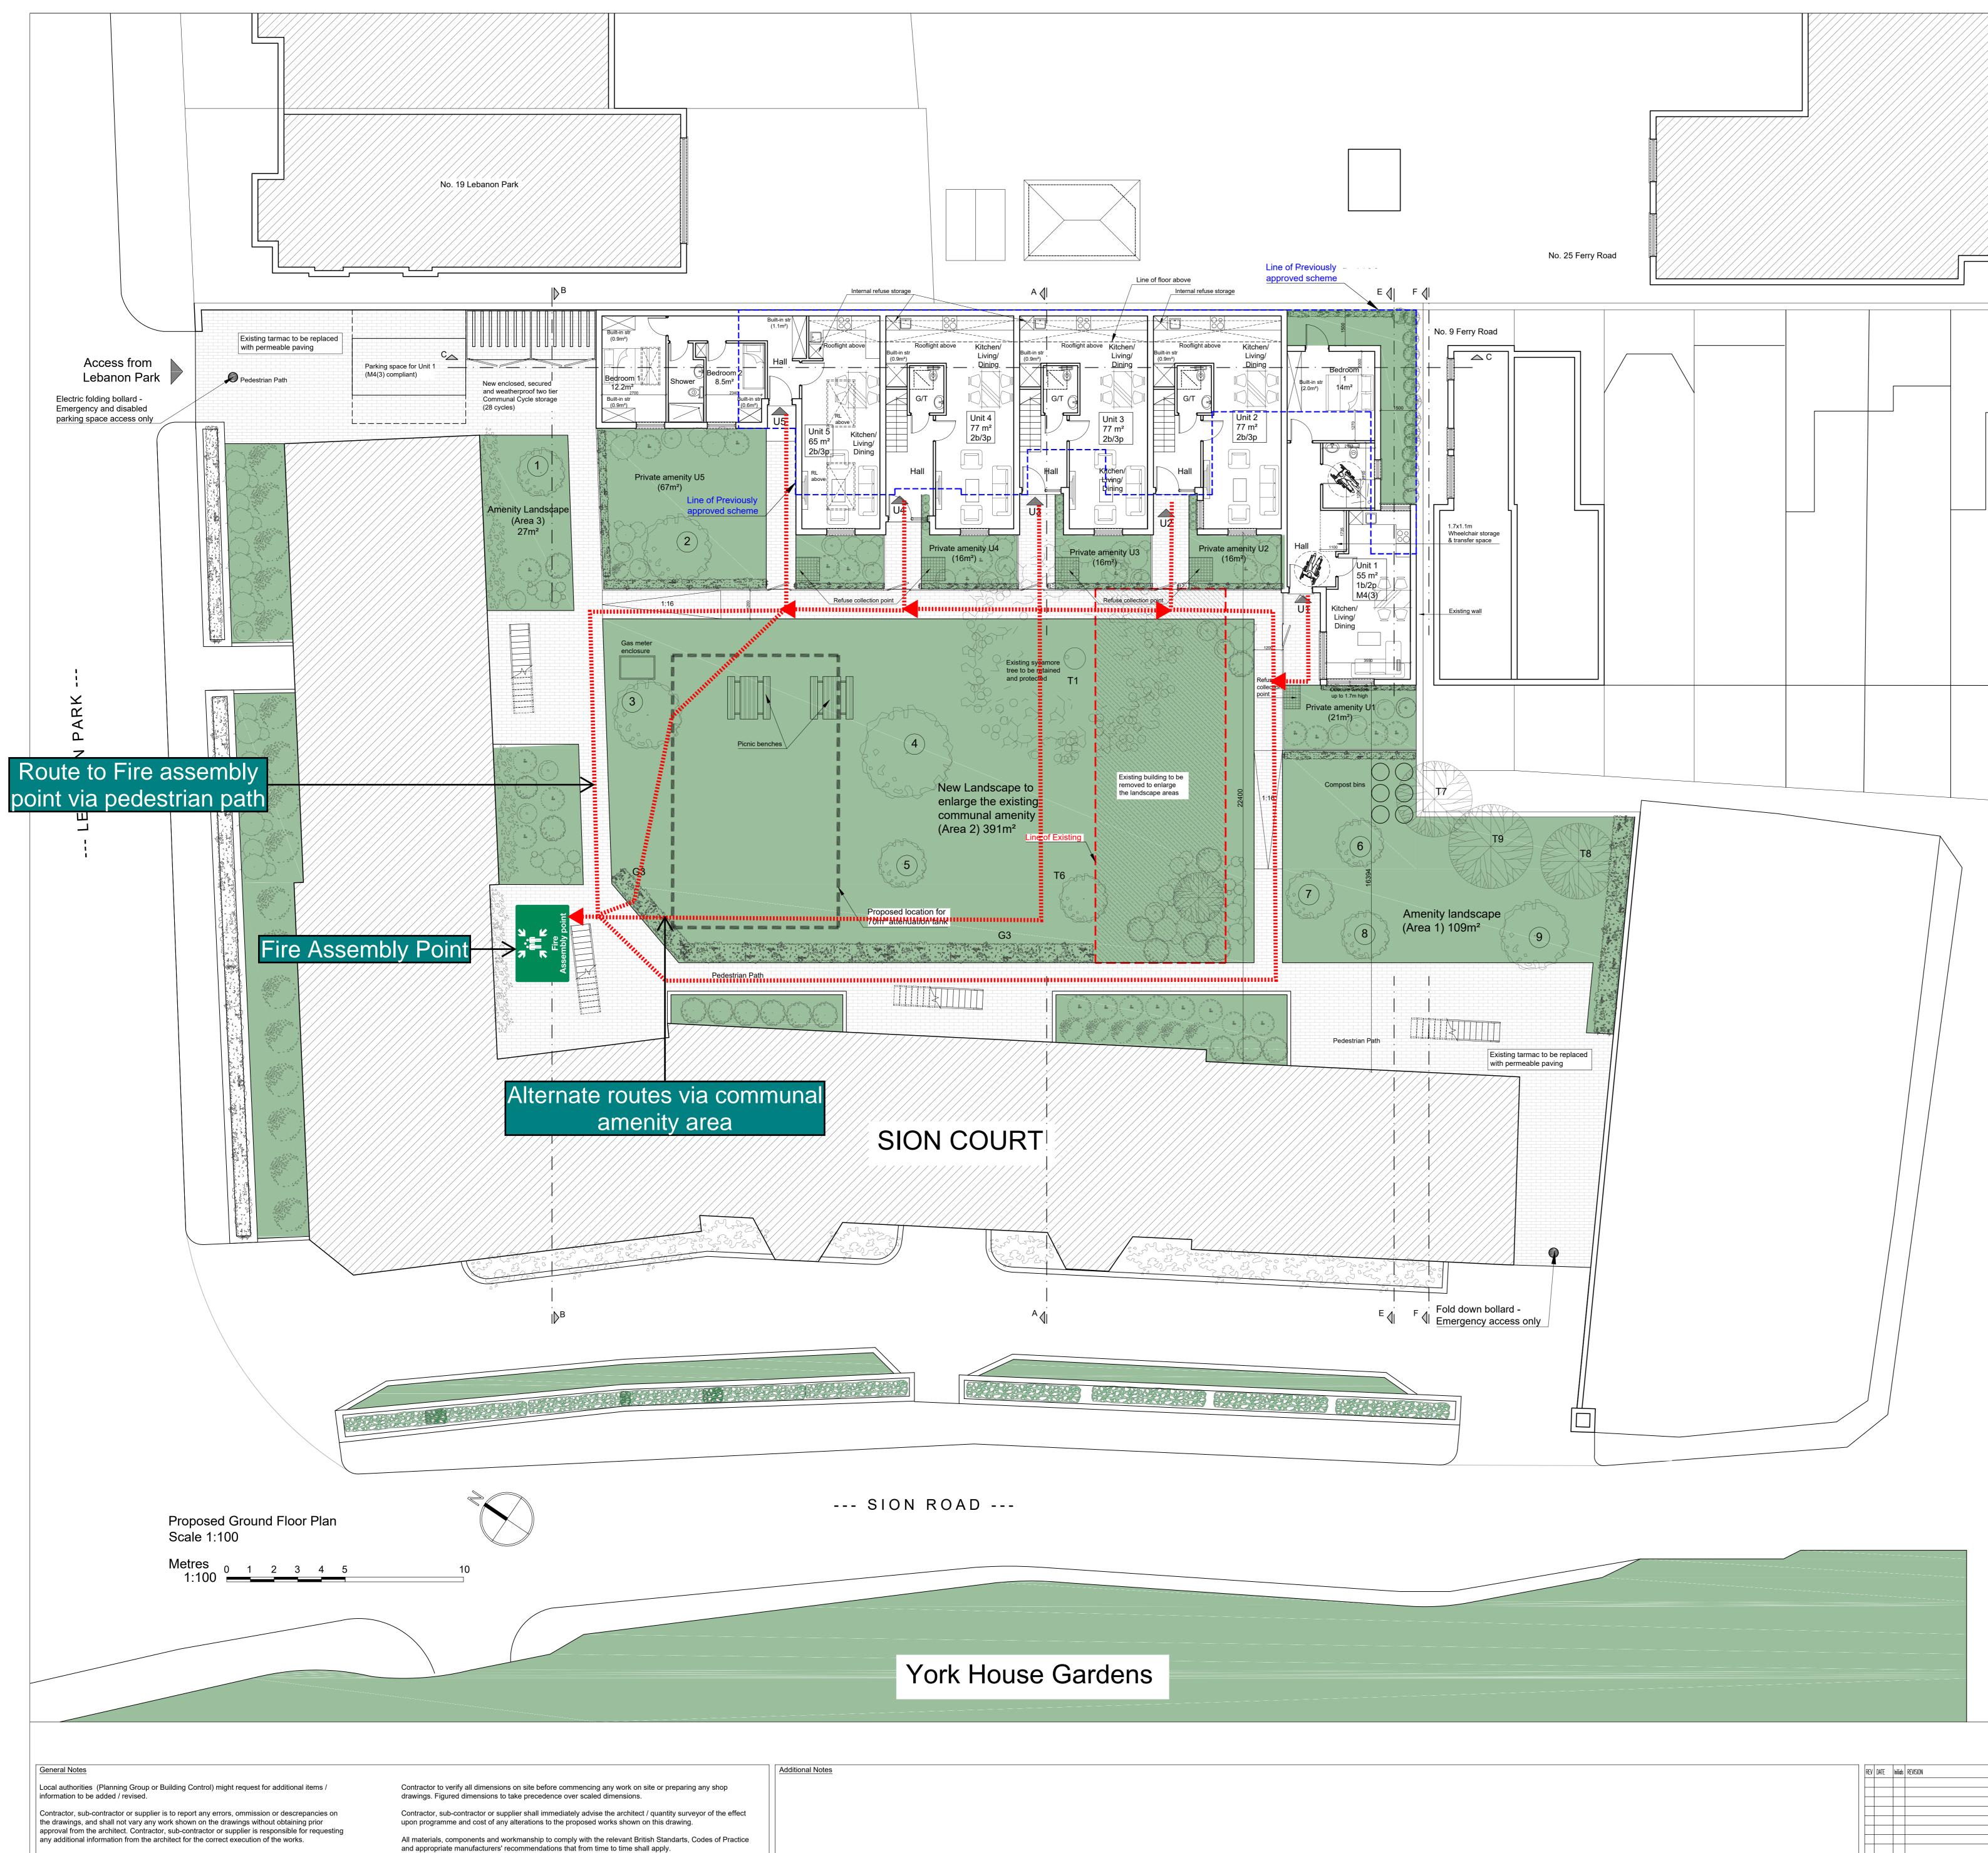
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, Prunus pandora 12-14cm, 45litre

ula albosinensis Fascination,14-16cm, 65 litre

lerina, 10-12cm, 45litre

1					
ZONE			TURE STATUS	TAL ARC LTD.	
LEVEL DRAWING NUM A SC-PP4-05		BER REVISION		ARCHITECTURE DESIGN	
PAPER SIZE	A0 SHEET			2a Crescent Road London N3 1HP, U.K.	
				T. 020 3719 0793	1
DRAWING TI	TLE Proposed G	Fround Flo	or Plan	E. INFO@TALARC.CO.UK W. www.talarc.co.uk	
SCALE 1:100	DATE 08/04/2024	DRAWN YS	CHECKED YS	PROJECT TITLE New Residential Unit	s at Sion Court



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	No. of bedrooms /
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TOTAL (m
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WASTE MANAG	SEME
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Each of the resid	lentia
Refuse collection will extend the c Court to the prop	urren
As part of the ma front garden of e	•

arrangement.

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REV	DATE	Initials	REVISION	PROJECT
				New Residential Units at Sion Court Twickenham, TW1 3DD
				CLIENT Moreland Residential (UP

Minimum Gross Internal Areas (GIA) and Storage						
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1b2p	50m² (1 storey)	55.6m²	39m²	2.1m²		
2b3p (2storey)	70m² (2 storey)	77m²	21.5m²	3.62m²		
2b3p (2storey)	70m² (2 storey)	77m²	21.5m²	3.62m²		
1b2p (2storey)	58m² (2 storey)	71.8m²	21.5m²	2.22m²		
 2b3p	61m² (1 storey)	65m²	67m²	2.69m²		

Amenity Landscape Areas						
Existing	Proposed	Added				
CON	IMUNAL FOR ALL RESI	DENTS				
34	109	75				
300	391	91				
-	27	27				
334	527	193				
	PRIVATE					
-	100	100				
	GREEN ROOFS					
-	191	191				
	Existing CON 34 300 -	ExistingProposedCOMMUNAL FOR ALL RESIN34109300391-27334527PRIVATE100-100GREEN ROOFS				

MENT PLAN

akes use of on-street servicing opportunities for all delivery and d refuse collections. The proposals will retain the same strategy for the l units.

tial units will be provided with internal refuse storage.

t the Site will be administered by on-site management personnel, who rent waste management arrangement for the existing 36 units at Sion ed units.

As part of the management regime, refuse and recycling will be collected daily from the front garden of each proposed unit to an allocated refuse storage point in the neighbouring building at Lebanon Court. Both buildings have the same managing agents and the same

s prunifolia Splendens, 12-14cm, 65litre

us hupehensis, 12-14cm, 45litre

Prunus serrula Tibetica, 12-14cm, 45litre


Koelruteria paniculata 20-25cm, 250litre.


, Prunus pandora 12-14cm, 45litre

ula albosinensis Fascination,14-16cm, 65 litre

(9) Amelanchier Ballerina, 10-12cm, 45litre

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ZONE			TURE STATUS	TAL ARC LTD.	
LEVEL DRAWING NUM A SC-PP4-05		BER REVISION		ARCHITECTURE DESIGN	
PAPER SIZE	A0 SHEET			2a Crescent Road London N3 1HP, U.K.	
				T. 020 3719 0793	1
DRAWING TI	TLE Proposed G	Fround Flo	or Plan	E. INFO@TALARC.CO.UK W. www.talarc.co.uk	
SCALE 1:100	DATE 08/04/2024	DRAWN YS	CHECKED YS	PROJECT TITLE New Residential Unit	s at Sion Court

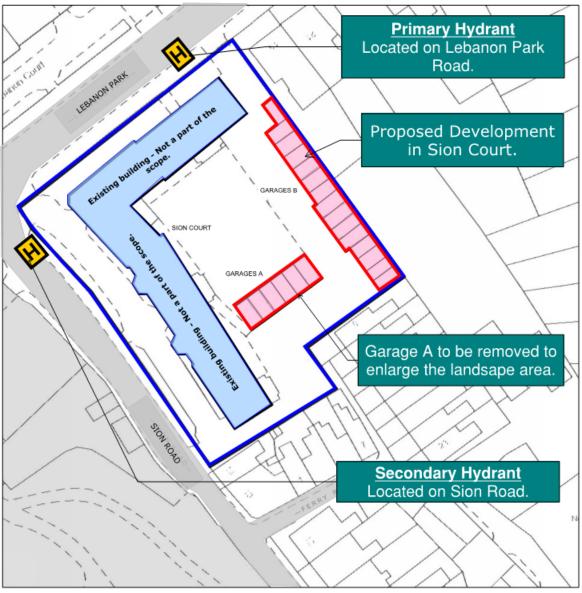

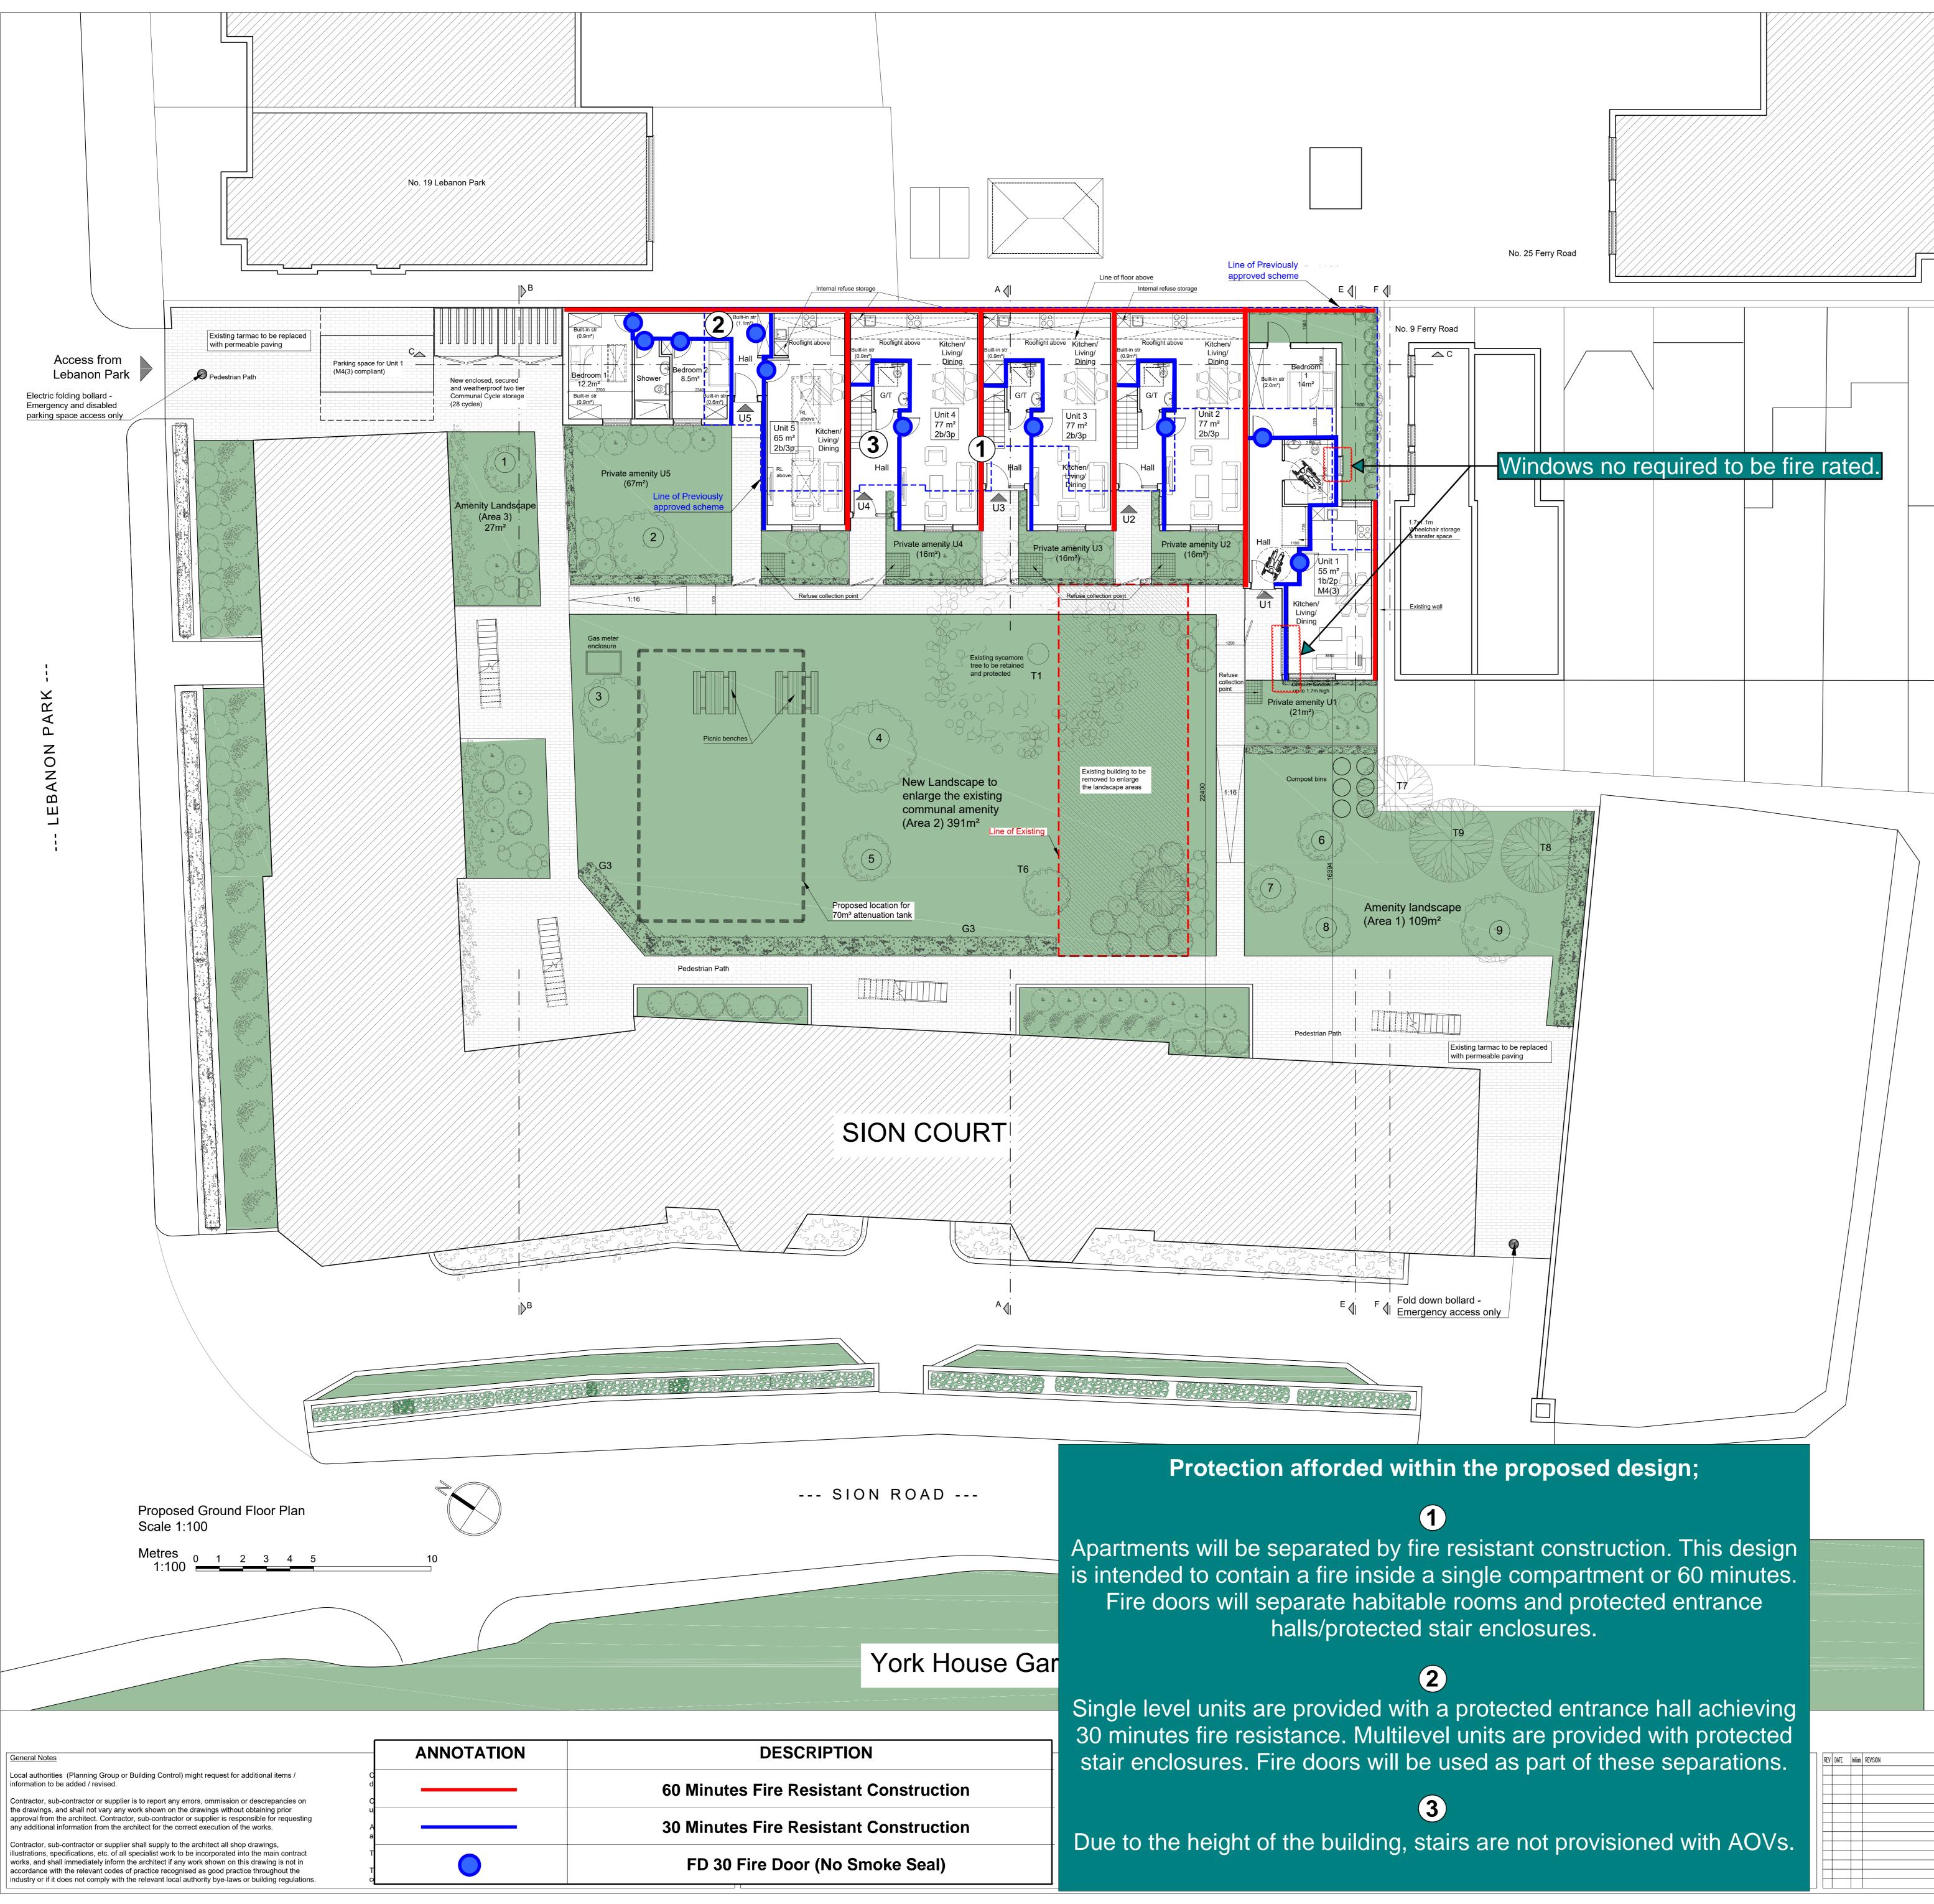

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REV	DATE	Initials	REVISION	F
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	Minimum Gross Internal Areas (GIA) and Storage				
	No. of bedrooms / persons	Min. London Plan flat area (m²)	Proposed flat area (m²)	Proposed private amenity (m²)	Proposed built-in storage (m²)
Unit 1	1b2p	50m² (1 storey)	55.6m²	39m²	2.1m²
Unit 2	2b3p (2storey)	70m ² (2 storey)	77m²	21.5m²	3.62m ²
Unit 3	2b3p (2storey)	70m ² (2 storey)	77m²	21.5m²	3.62m ²
Unit 4	1b2p (2storey)	58m² (2 storey)	71.8m²	21.5m²	2.22m ²
Unit 5	2b3p	61m² (1 storey)	65m²	67m²	2.69m²

	Amenity Landscape Areas			
	Existing	Proposed	Added	
	COM	MUNAL FOR ALL RESIDE	ENTS	
Amenity Landscape 1 (m²)	34	109	75	
Amenity Landscape 2 (m²)	300	391	91	
Amenity Landscape 3 (m²)	-	27	27	
TOTAL (m ²)	334	527	193	
		PRIVATE		
rivate Amenity Landscape (m²)	-	100	100	
	GREEN ROOFS			
Green Roofs (m ²)	-	191	191	

The existing Amenity Landscape is 334m². The proposal adds Communal amenity landscape of <u>193m</u>² New Communal Amenity Lansdcape area is a <u>Total of 527m</u>². Total Landscape area (including Private amenity landscape and Green roofs) is 818m².

WASTE MANAGEM	
The existing Site ma servicing activity and proposed residential	ł
Each of the resident	ia
Refuse collection at will extend the curre Court to the propose	n
As part of the manager front garden of each building at Lebanon arrangement.	ł

NEW TREE PLANTI
1. Thorn, Crataegus
(2) Crab apple, Malus
3. Tibetan cherry, Pru
(4) Golden rain tree, k
(5) Flowering cherry, I
6, 7, 8 Birch, Betula
(9) Amelanchier Balle

PROJECT
New Residential Units at
Sion Court
Twickenham, TW1 3DD
CLIENT

Moreland Residential (UK)

WASTE MANAGEMENT PLAN

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Prunus pandora 12-14cm, 45litre

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erina, 10-12cm, 45litre

1					
ZONE	DISCIPLINE ARCHITECT	TURE	status PLANNING	TAL ARC LTD.	
LEVEL A	DRAWING NUM	1BER	REVISION	ARCHITECTURE DESIGN	
PAPER SIZE	A0 SHEET			2a Crescent Road London N3 1HP, U.K.	
				T. 020 3719 0793	1
DRAWING TITLE Proposed Ground Floor Plan			or Plan	E. INFO@TALARC.CO.UK W. www.talarc.co.uk	
SCALE 1:100	DATE 08/04/2024	DRAWN YS	CHECKED YS	PROJECT TITLE New Residential Unit	s at Sion Court

ANNOTATION	DESCRIPTION
	60 Minutes Fire Resistant Construction
	30 Minutes Fire Resistant Construction
	FD 30 Fire Door (No Smoke Seal)

halls/protected stair enclosures.

