




PROPOSED ELEVATION SIDE A
SCALE 1:100

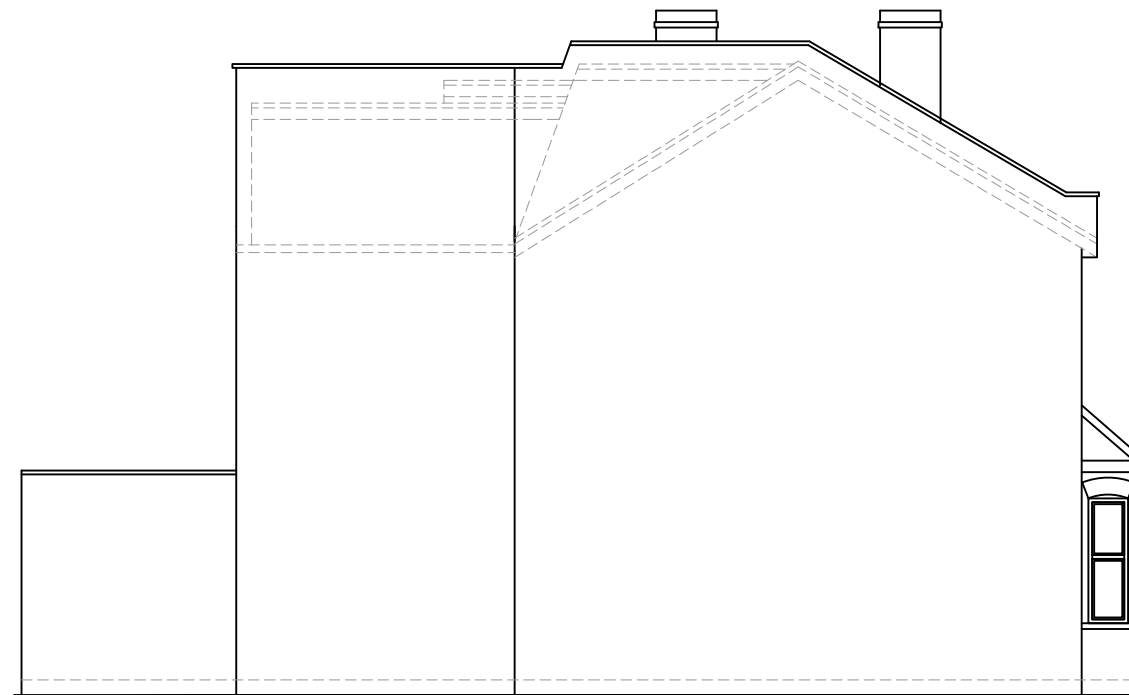

PROPOSED ELEVATION SIDE B
SCALE 1:100

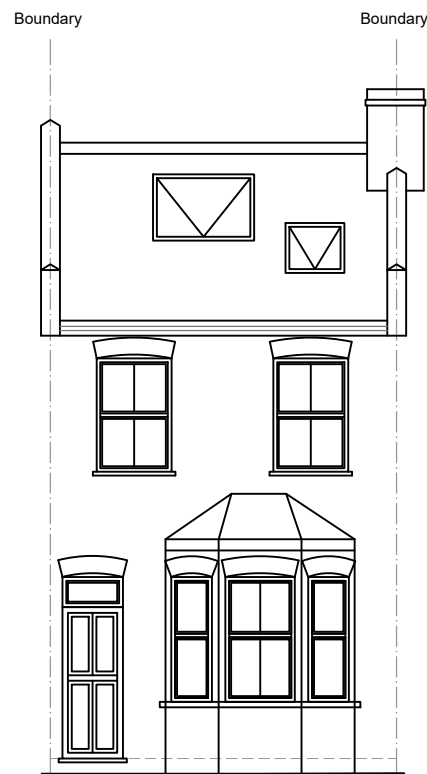

PROPOSED FRONT ELEVATION
SCALE 1:100

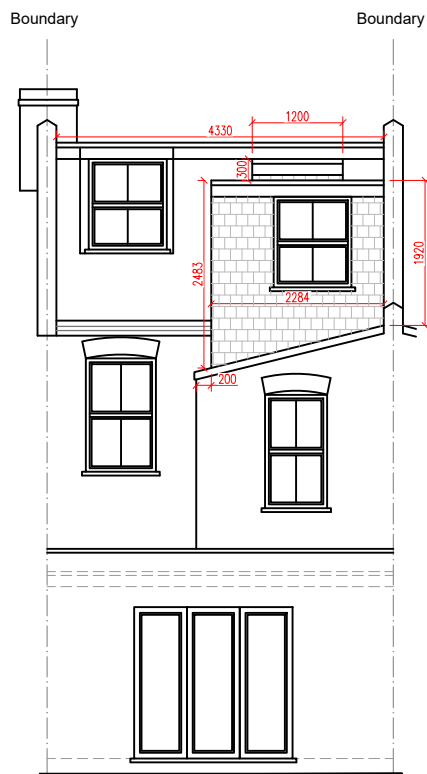

PROPOSED REAR ELEVATION
SCALE 1:100

⊗ = LOFT DORMER (A)

$$\frac{\textcircled{A} \textcircled{B}}{2} = \frac{3.48 \times 2.17}{2} = 3.77$$

$$= 3.77 \times 4.33 = 16.32$$

⊙ = LOFT DORMER (B)

$$\frac{\textcircled{A} \textcircled{B}}{2} = \frac{2.48 + 1.92}{2} = 2.20 \times \textcircled{C} = 2.20 \times 2.28 = 5.01$$

⊚ = LOFT DORMER (B)

$$\frac{\textcircled{A} \textcircled{B}}{2} = \frac{0.30 + 0.30}{2} = 0.30 \times \textcircled{C} = 0.30 \times 1.20 = 0.36$$

$$= 0.36 \times 1.50 = 0.54$$

TOTAL VOLUME

$$= X + Y + Z$$

$$16.32 + 18.43 + 0.54 = 35.29$$

$$35.29\text{m}^3 < 40\text{m}^3$$

5m 1:50
10m 1:100

9

8

7

6

5

4

3

2

1

0



www.FastPlansUK.co.uk

Project: DORMER OVER REAR
ADDITION ROOF.

Address:
75 HEATH GARDENS, TW1 4LY

Scale: 1:100 @ A3

Dwg. no:
A06

Drawn by:
O.B.S

Date Drawn:
02-MAR-2024

For Drawings Tel: 0208 154 5569

E-mail: plans@FastPlansUK.co.uk