



20.00m
19.00m
18.00m
17.00m
16.00m
15.00m
14.00m
13.00m
12.00m
11.00m
10.00m
9.00m
8.00m

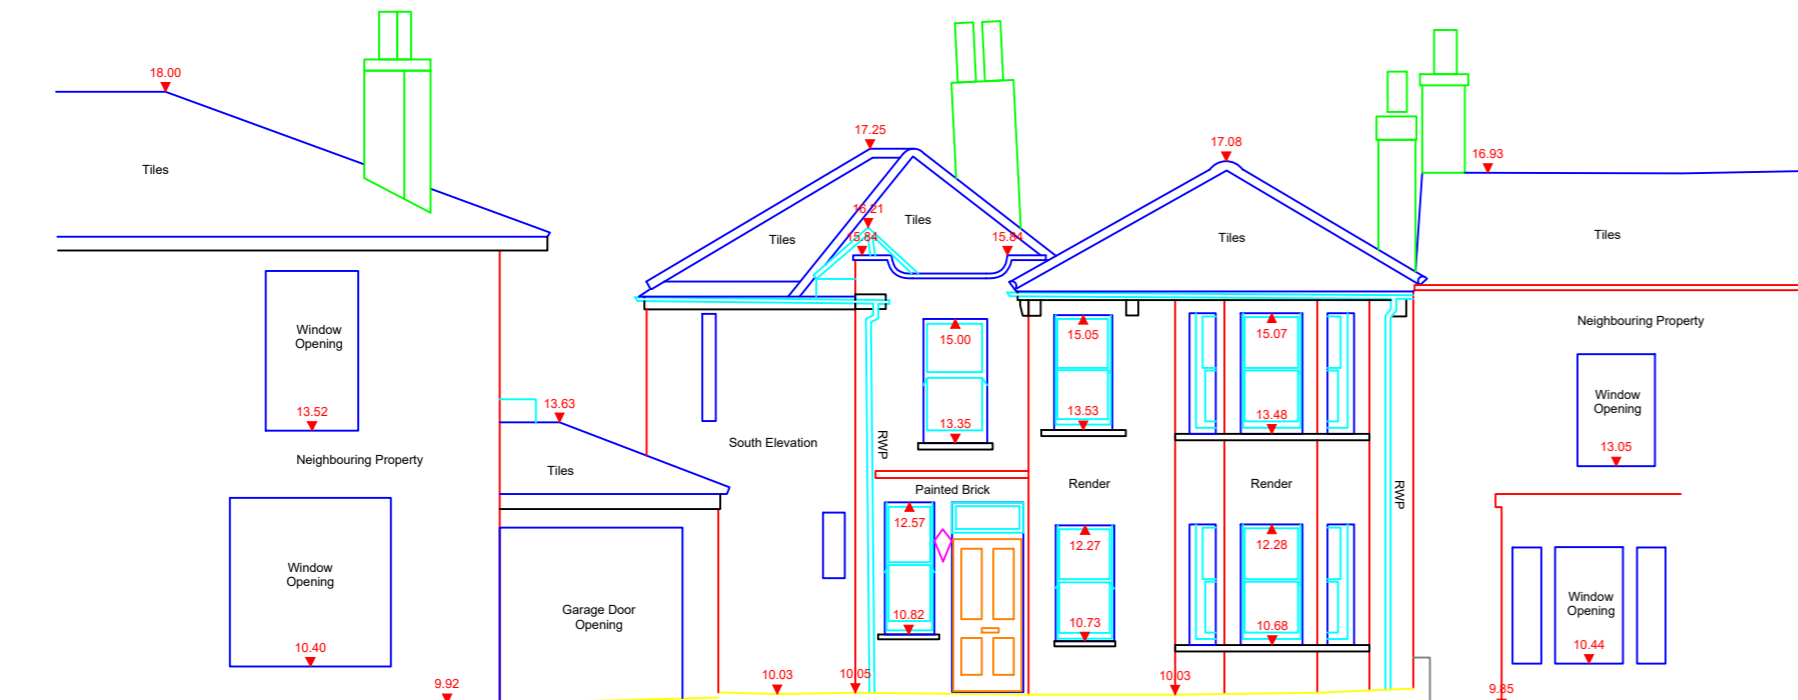


DATUM 7.00M

EXISTING EAST ELEVATION

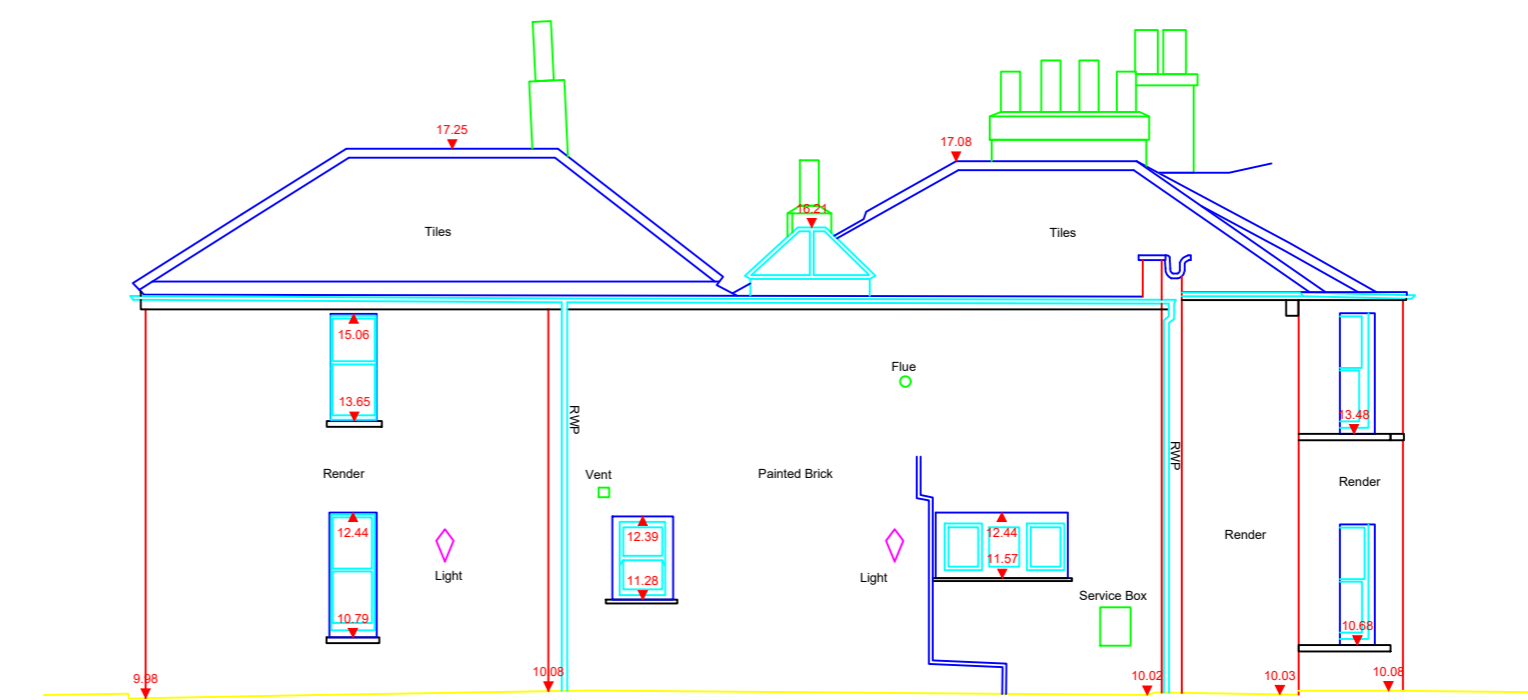


DATUM 7.00M

EXISTING SOUTH ELEVATION

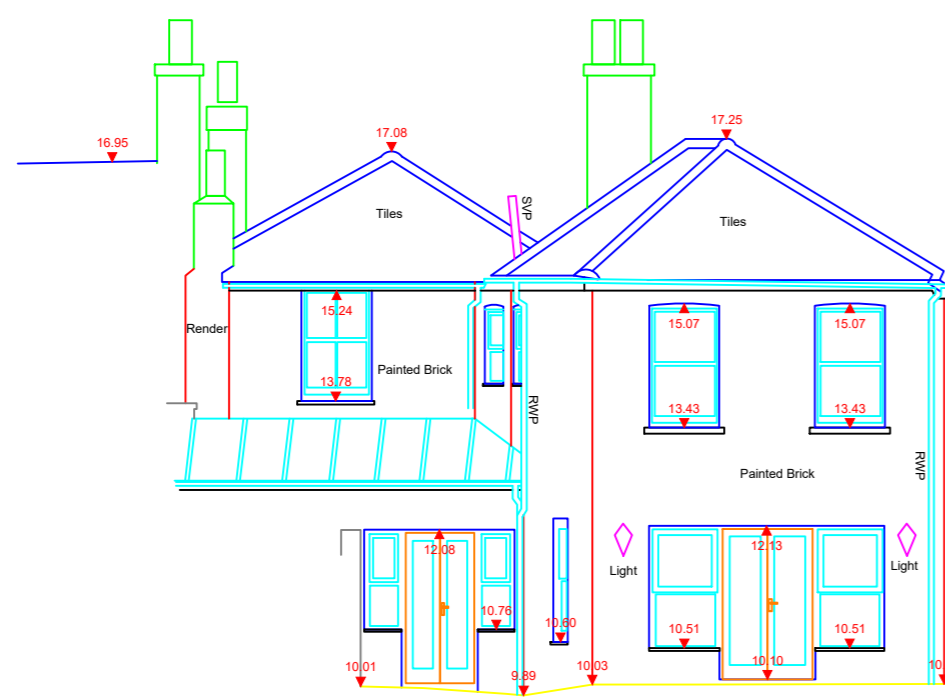

DATUM 7.00M

EXISTING WEST ELEVATION

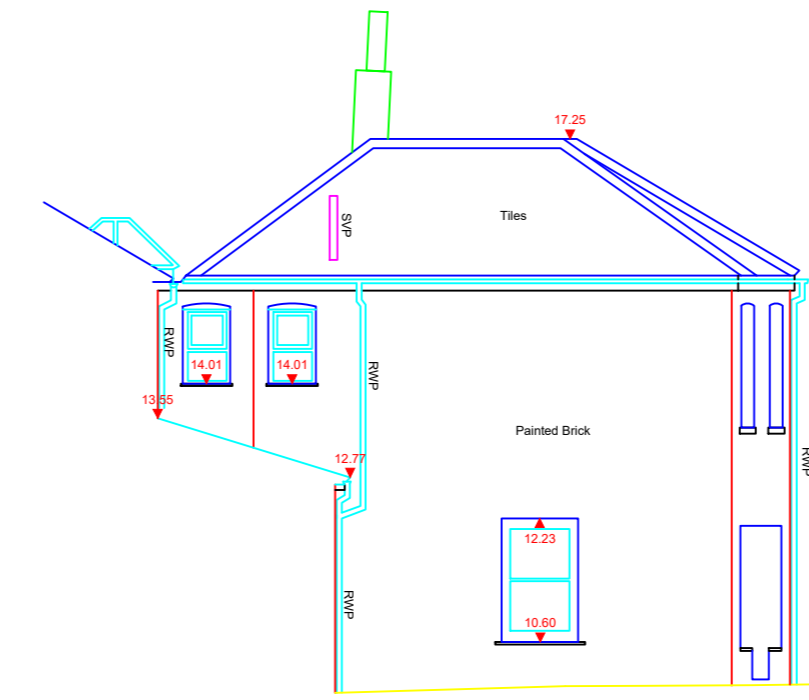

DATUM 7.00M

EXISTING NORTH ELEVATION

20.00m
19.00m
18.00m
17.00m
16.00m
15.00m
14.00m
13.00m
12.00m
11.00m
10.00m
9.00m
8.00m

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Drawing Naming Convention:
Job No/Dwg type/Location/Ref

Dwg Type: T = Topographical E = Elevation
FP = Floor Plan S = Section
Location: B = Basement 2 = Second
0 = Ground R = Roof
1 = First M = Mezzanine
Ref Reference to individual layout ID or Revision.

Standard Abbreviations (where applicable):
Building Survey Land Survey

AB AIR BRICK	BB BOLLARD
ACU AIR CONDITIONING UNIT	BT BELISHA BEACON
AH ACCESS HATCH	BT COVER
AP ACCESS PANEL	CAM CAMERA
AV AIR VALVE	CATV CABLE TV COVER
BH BEAM HT	CL COVER LEVEL
BR BOILER	ELEC ELECTRIC COVER
BSL BEAM SOFFIT LEVEL	EP ELECTRIC POLE
CB CUPBOARD	ER EARTH ROD
CC CEILING CHANGE	FP FLAG POLE
CH CLEAR INTERNAL HT	FW Foul WATER
C-A CALL TO APEX HT	GU GULLY
C-H CALL TO HEAD HT	GV GAS VALVE
C-S CALL TO SPRING HT	FH FIRE HYDRANT
DB DOOR BASE HT	IC INSPECTION COVER
DH DOOR HEAD HT	IL INVERT LEVEL
DR DRAM	LP LAMP POST
ENF EXTRACTOR FAN	MH MANHOLE
FA FIRE ALARM	OHT OVERHEAD TELECOM
F-A FLOOR TO APEX HT	P POST
F-C FLOOR TO CILL HT	PM PARKING METER
F-H FLOOR TO HEAD HT	PI PIPE
F-S FLOOR TO SPRING HT	RD RODDING EYE
GEA GROSS EXTERNAL AREA	RS ROAD SIGN
GIA GROSS INTERNAL AREA	RTW RETAINING WALL
GU GULLY	RWP RAIN WATER PIPE
HT HEATER	SA SITE AREA
HW HOT WATER TANK	SI SIGN
NIA NET INTERNAL AREA	SL SOFFIT LEVEL
NTS NOT TO SCALE	SV STOP VALVE
RAD RADIATOR	SVP SOIL VENT PIPE
RE RECESS HEAD HEIGHT	SW STORM WATER
RFV RAISED FLOOR VOID	TOP TOP OF FENCE
RL ROOF LIGHT	TOW TOP OF WALL
RSH ROLLER SHUTTER	TP TELEGRAPH POLE
RWP RAIN WATER PIPE	UTL UNABLE TO LIFT
SVP SOIL VENT PIPE	VP VENT PIPE
VA WARDROBE	WM WATER METER
WT WATER TAP	WT WATER TAP

Symbols (where applicable):

Direction of sloping ceiling CH 2.05 FL 10.00
FLOOR TO CEILING HEIGHT FLOOR LEVEL RELATIVE TO DATUM

Notes:
The Survey relates to an arbitrary grid & level.
All Levels are in metres and relate to finished floor level in the Entrance Hall. Level taken at 10.00m.
All direction arrows indicate LIP unless otherwise stated.
Visible features in the vicinity of any boundaries, as shown on this survey, may not represent the extent of legally conveyed ownership.
Whilst every effort has been made to determine wall materials, no guarantee is given. Materials should be regarded as assumed unless verified by a qualified third party.
Tree spread and height are approximate. Species should be regarded as assumed unless verified by a qualified third party.

Key plan

Rev	Date	By	Description

PIN POINT SURVEYS

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Client: MR & MRS MORRIS

Project: 16 HAM COMMON, LONDON, TW10 7JB

Drawing Title: EXISTING ELEVATIONS

Date: OCT-22	Scale: 1:100	Surveyor: RJB	Drawn: RJB	Checked: PPS
Job No: 22/215	Drawing No: 22215-E	Sheet No: 1 of 1	Rev: -	