




PROPOSED FRONT ELEVATION

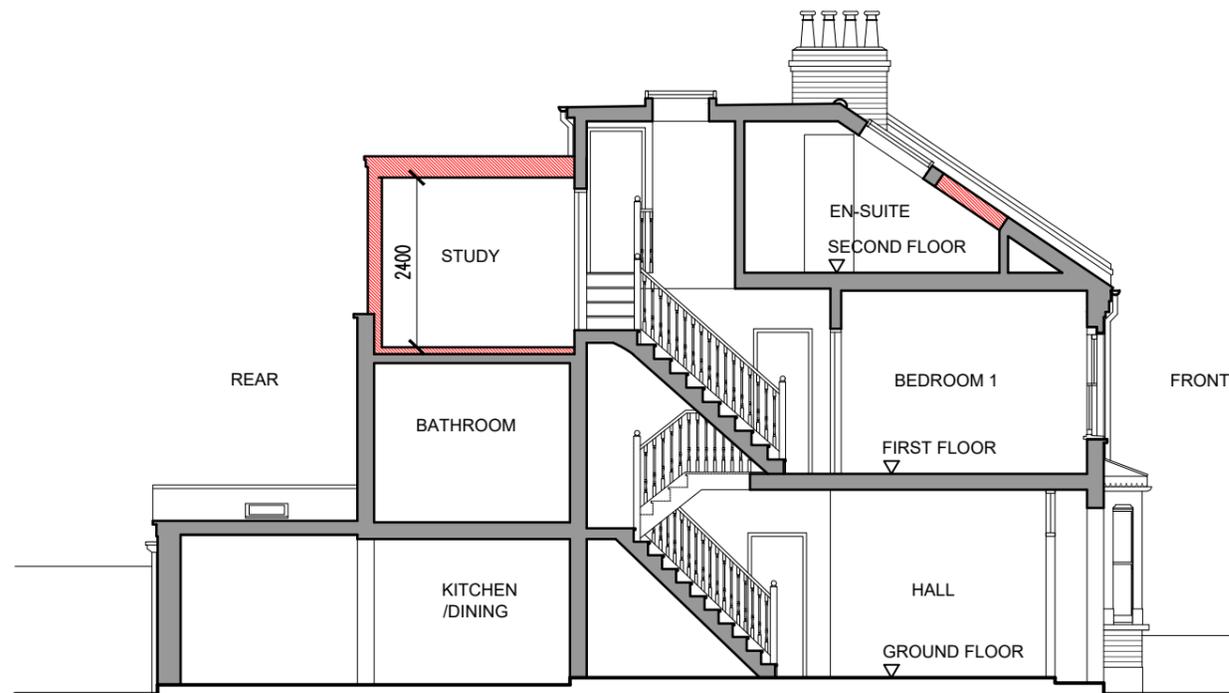

PROPOSED SECTION A

## NOTES

THIS DRAWING IS THE COPYRIGHT OF THE ARCHITECT


### SCHEDULE OF PROPOSED MATERIALS:

- WINDOWS** - UPVC SASHES, DOUBLE GLAZED (COLOUR TO MATCH GROUND FLOOR REAR DOOR)
- DORMER CHEEKS** - SYNTHETIC OR NATURAL SLATE TILES, COLOUR AND SIZE TO MATCH EXISTING
- FLAT ROOF** - DARK GREY WATERPROOFING MEMBRANE
- MAIN ROOF** - SLATE ROOF TO BE REPAIRED/REPLACED TO MATCH EXISTING WHERE NECESSARY
- RAINWATER GOODS** - BLACK UPVC


### VOLUME CALCULATIONS

- EXISTING REAR DORMER EXTENSION  
 $V1 = (1/2 A1 \times B1) \times C1$   
 $V1 = (1/2 3.65 \times 2.50) \times 4.45 = 20.3 \text{ m}^3$
- PROPOSED OUTRIGGER DORMER EXTENSION  
 $V2 = (1/2 (B2+B3) \times C2) \times A2$   
 $V2 = (1/2 (2.10 + 2.85) \times 2.60) \times 2.95 = 19 \text{ m}^3$

**TOTAL VOLUME**  
**V = 39.3 M3**

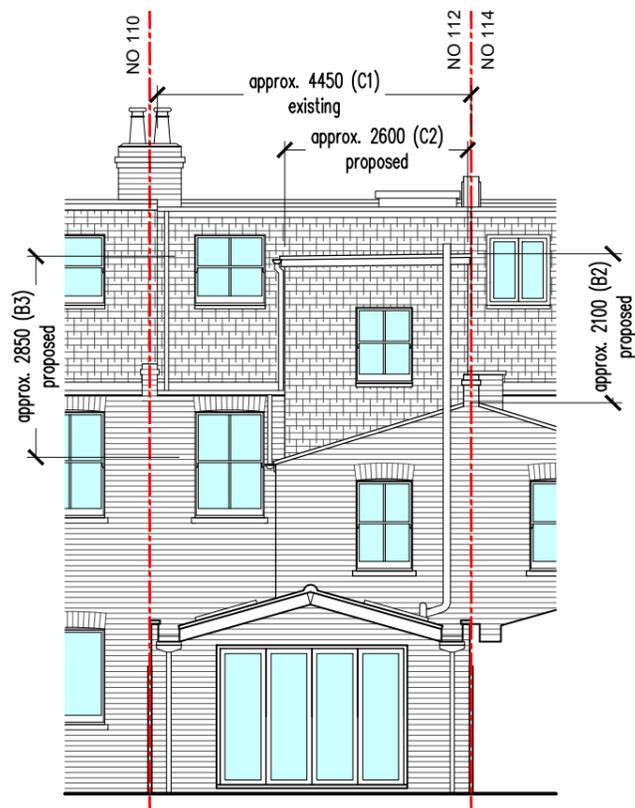

PROPOSED REAR ELEVATION

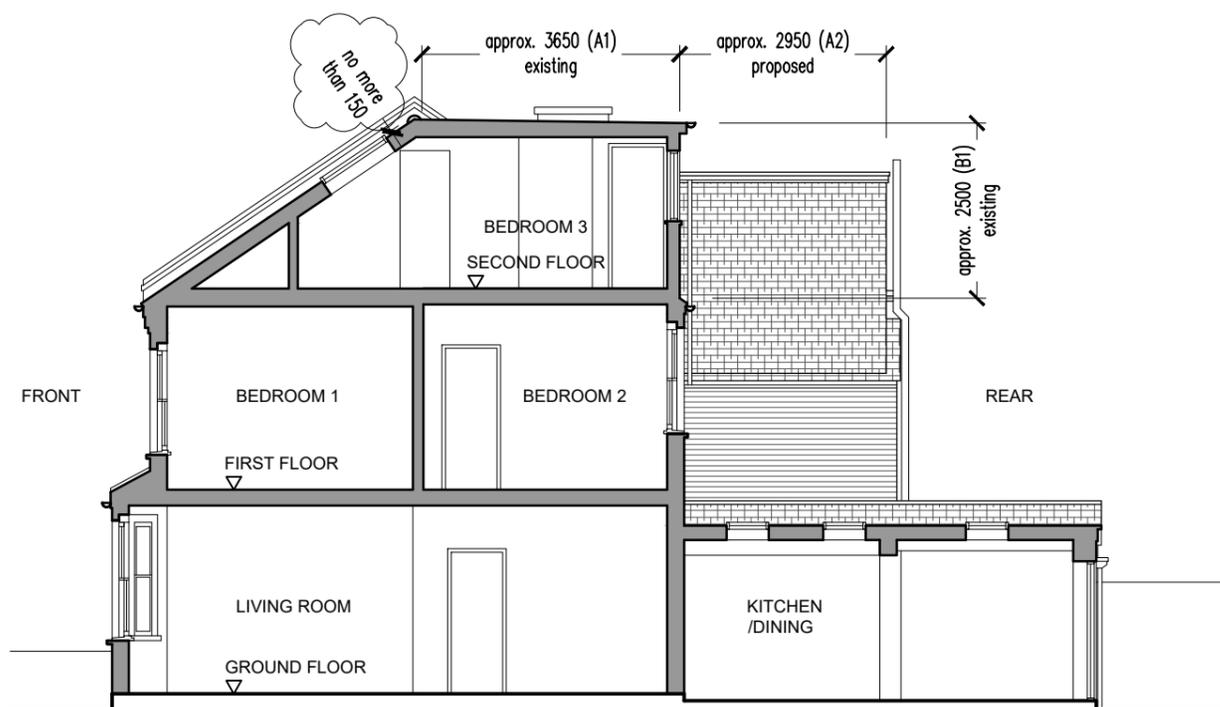

PROPOSED SECTION B AND SIDE ELEVATION


B 15.08.2024 Note added  
 REV DATE DESCRIPTION



PROJECT  
 PROPOSED ERECTION OF A DORMER ROOF EXTENSION TO REAR OUTRIGGER

112 FULWELL ROAD  
 TW11 0RQ TEDDINGTON

DRAWING TITLE  
 PROPOSED ELEVATIONS AND SECTIONS A&B

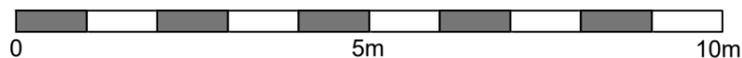

DRAWING No PL05B SCALE 1:100@A3 DATE APRIL '24