

# PROPOSED TYPE A (FD30) DOOR TYPICAL JAMB, CILL & HEAD

40mm 200mm Scale 1:2


**Butler Hegarty Architects**Unit 3.3, Islington Studios, 159-163 Marlborough Road, London, N19 4NF tel: 020 72638933 email: mail@butlerhegartyarchitects.co.uk

## To be read in conjunction with BHA Drawings:


Sk131\_Proposed 2nd Floor Door Type A nDS02,03 & 04 Details (2of2) Sk35\_Proposed Second Floor Setting Out Plan 1:50 Sk918\_Location Plans For Proposed New Internal Doors

16 St. Peters Road Title: Proposed 2nd Floor Door Type A nDS02,03 & 04 Details (2of2) Drawing No: 0122823-**Sk131** 

DO NOT SCALE

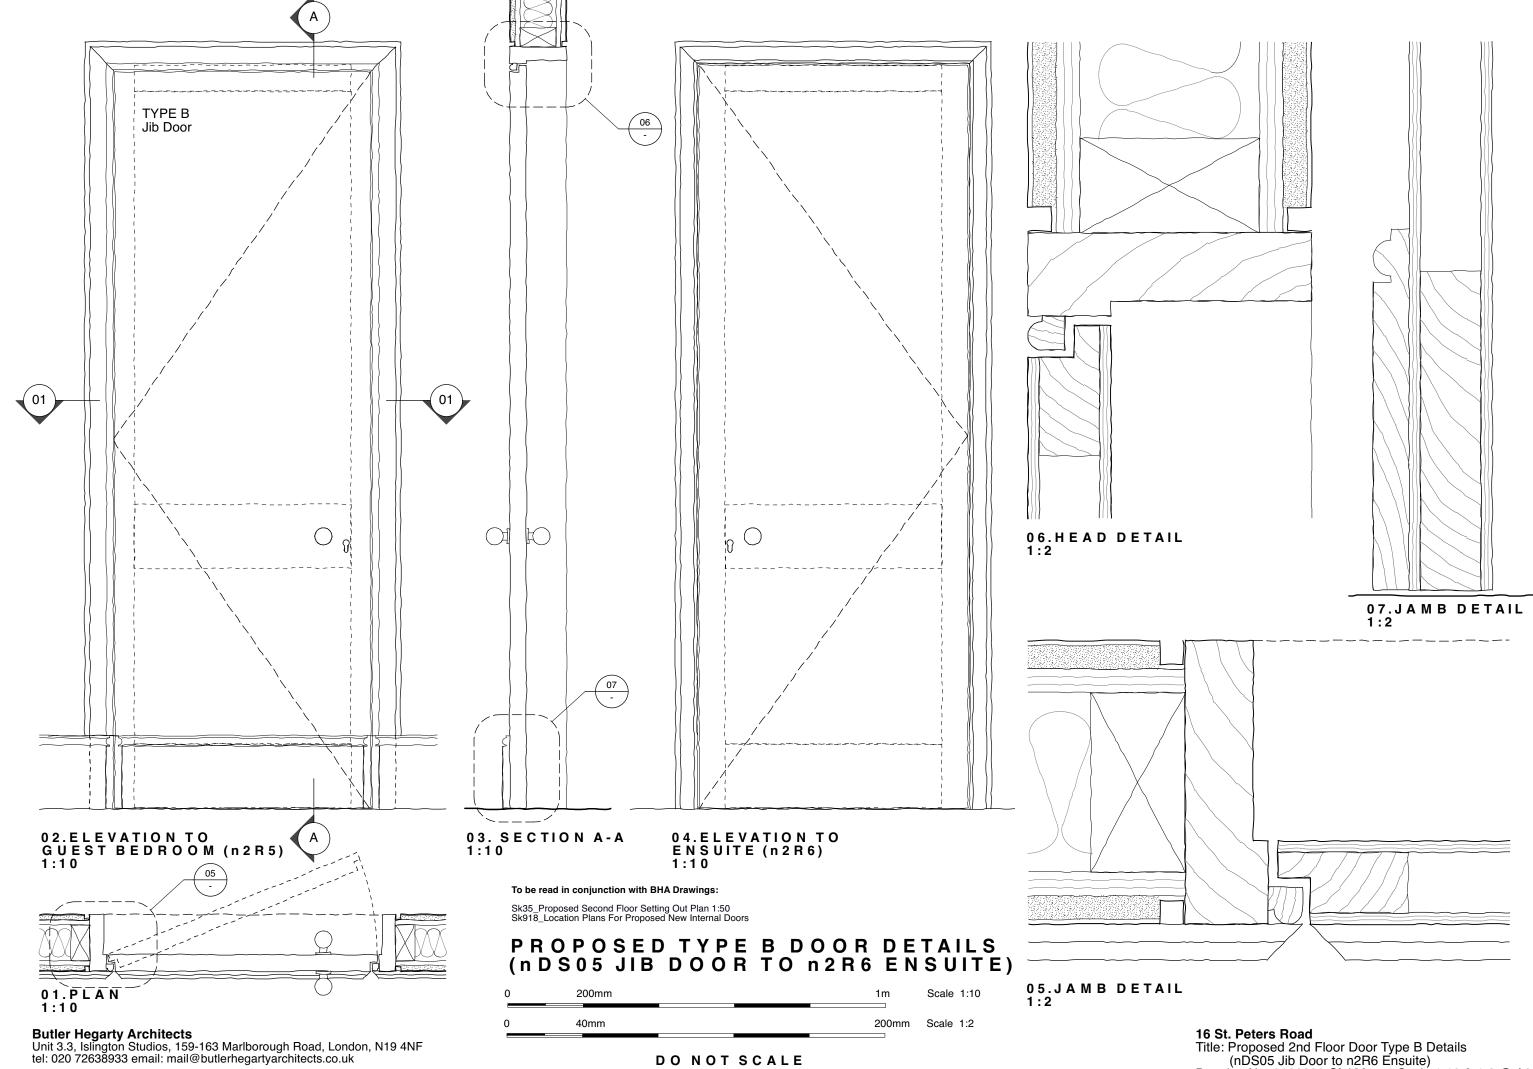

16 St. Peters Road
Title: Proposed 2nd Floor Door Type B Details
(nDS05 Jib Door to n2R6 Ensuite)
Drawing No: 0122823-Sk132 Scale 1:10 & 1:2 @ A3

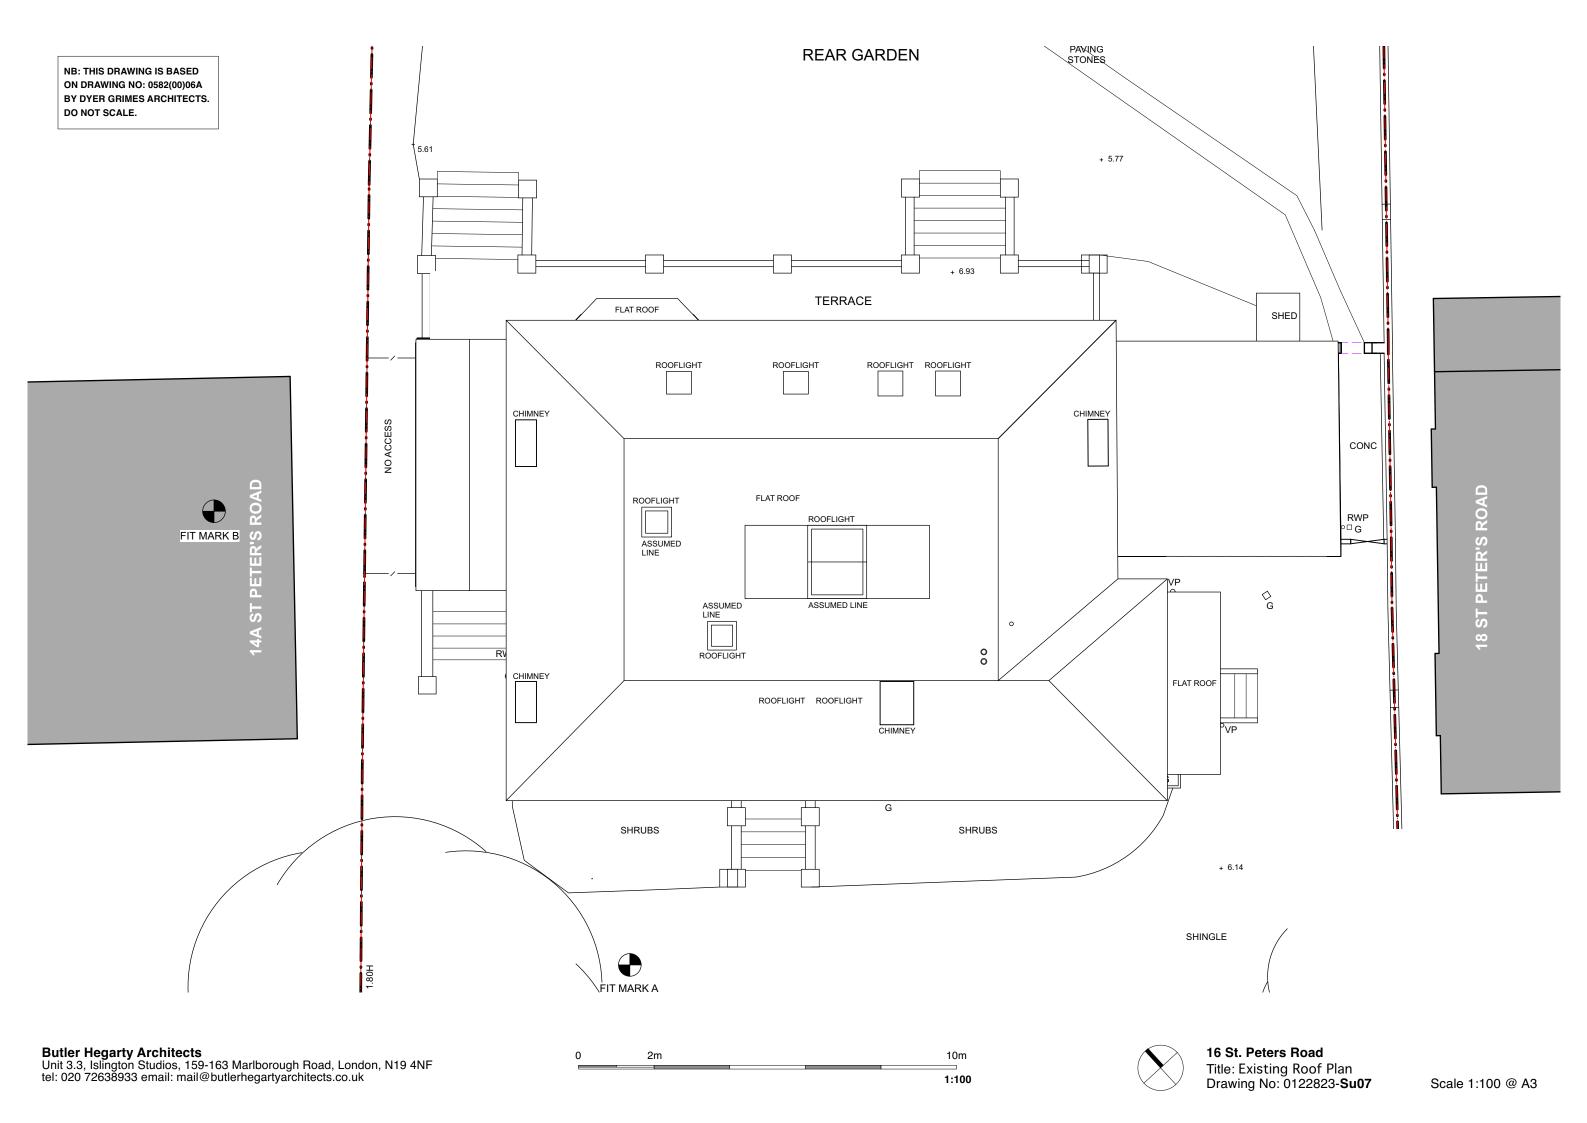



**03.** Existing Service Vent Pipes (Feburary 2023)



**01.** Existing Roof looking towards 14a St Peters Road (Feburary 2023)







**04.** Existing Rear Elevation from Younique Gardens (Feburary 2023)



**02.**Existing Roof looking towards 18 St Peters Road (Feburary 2023)

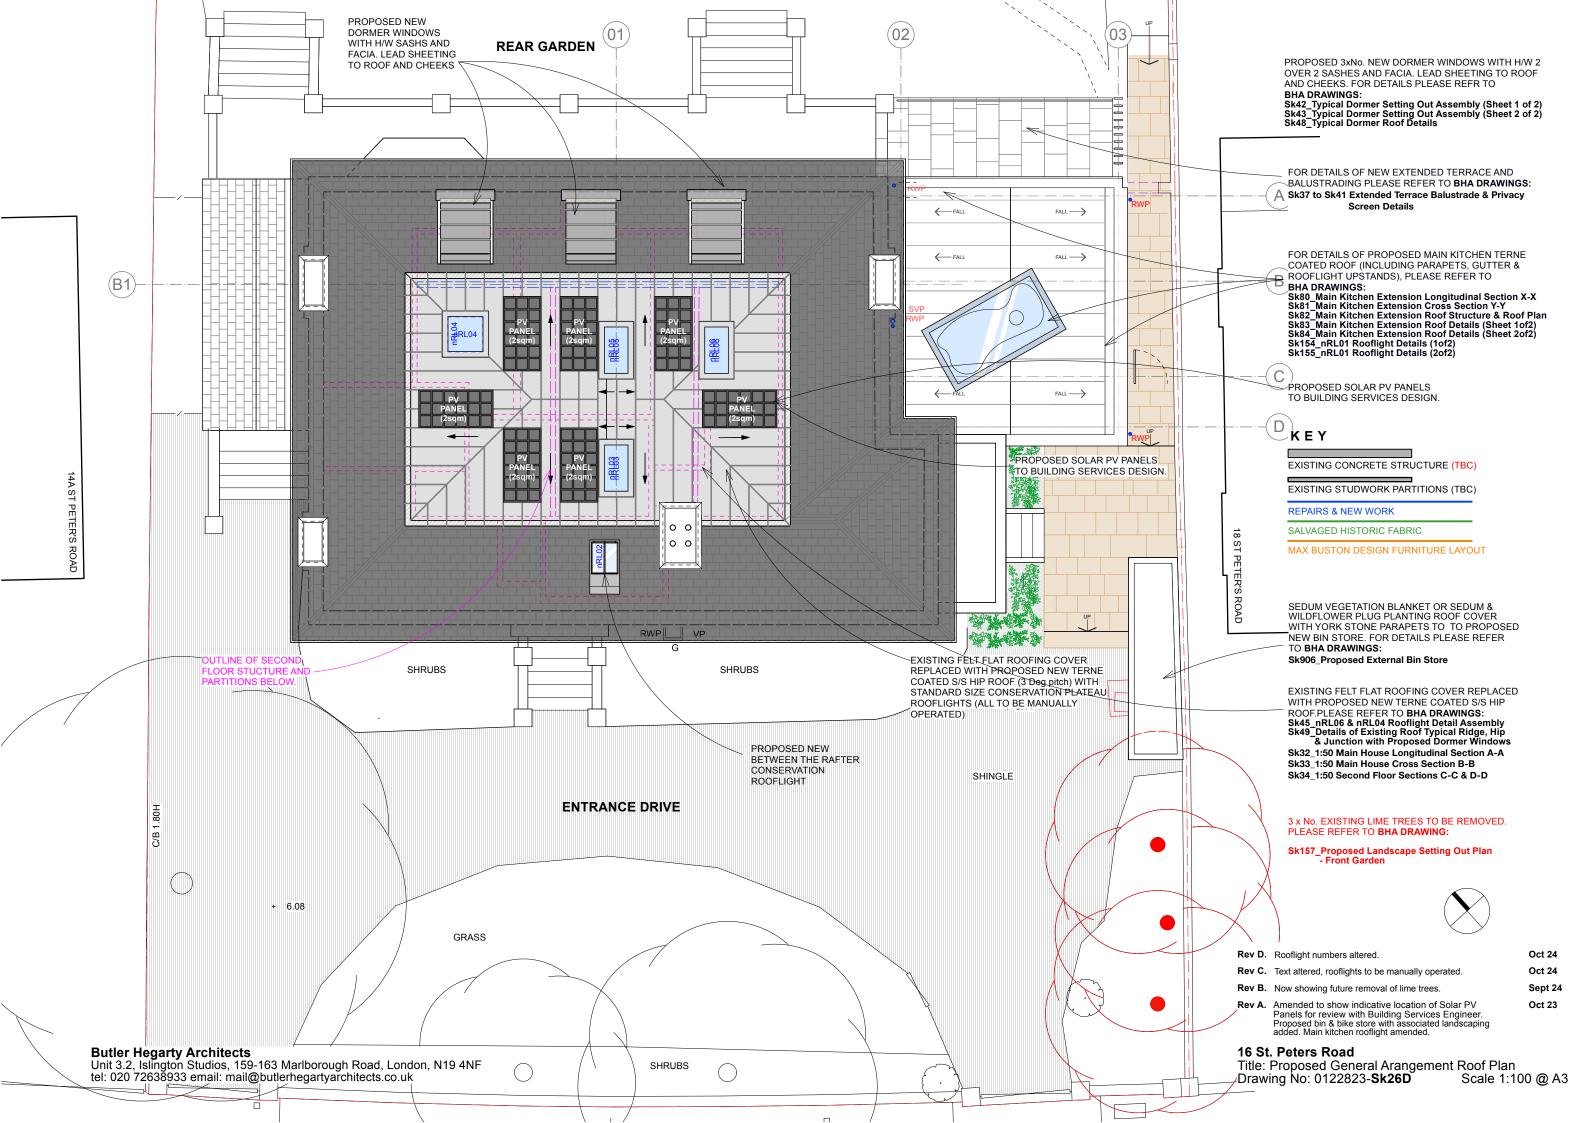

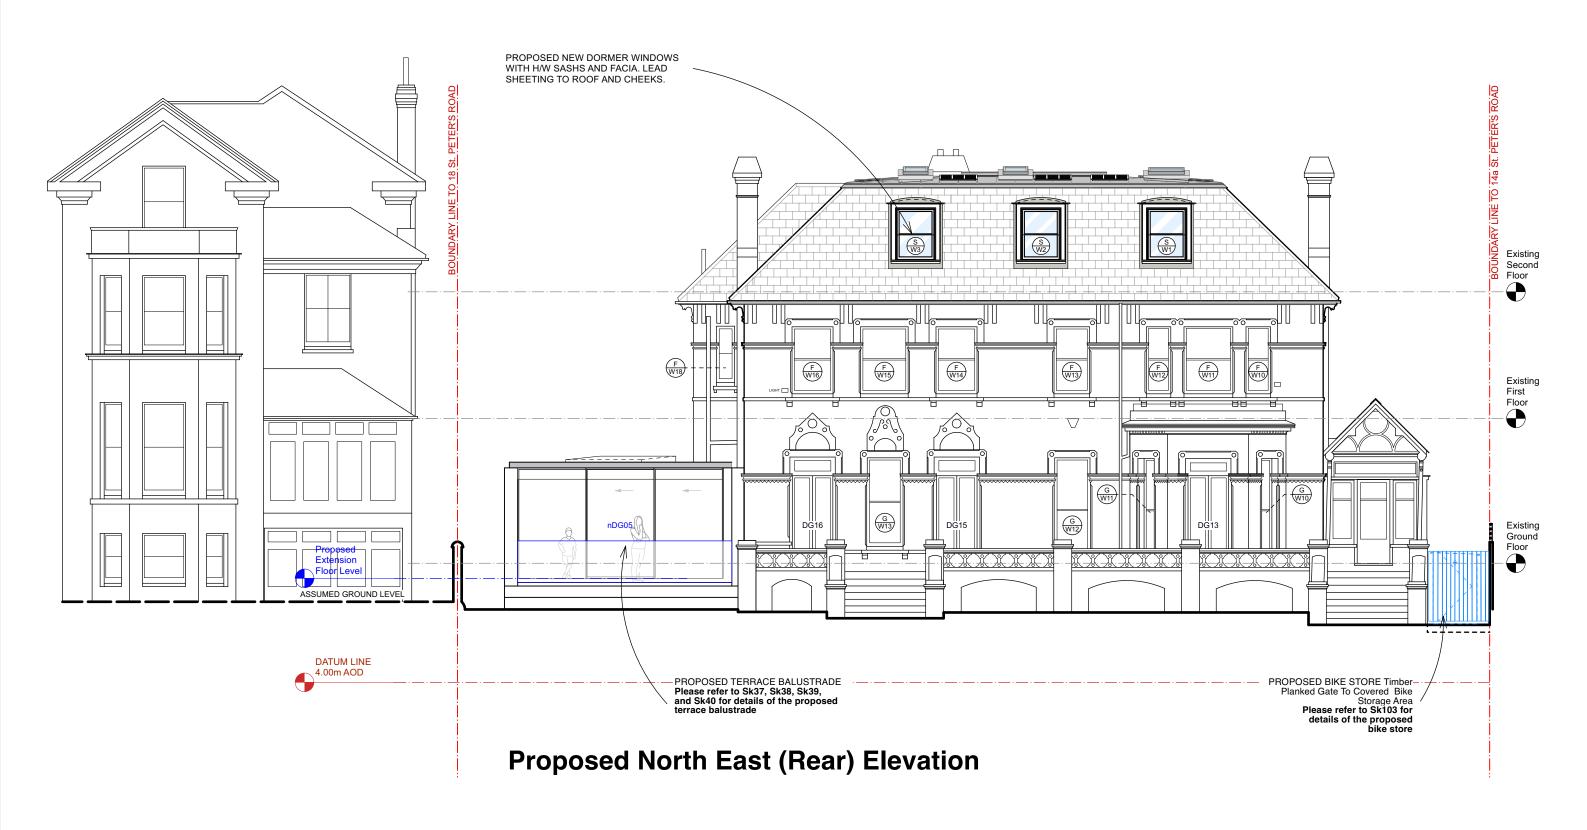

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2m 10m 1:100 Rev A. Alterations shown in blue

Oct 24

**Butler Hegarty Architects** 

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400mm 2m Scale 1:20


DO NOT SCALE


**Rev A.** Drawing updated & amended to discharge LBC/Planning conditions.


Jul 24

16 St. Peters Road

Title: Conservation Rooflight nRL02 Detail Assembly. Drawing No: 0122823-**Sk44A** Scale 1:20 @ A3

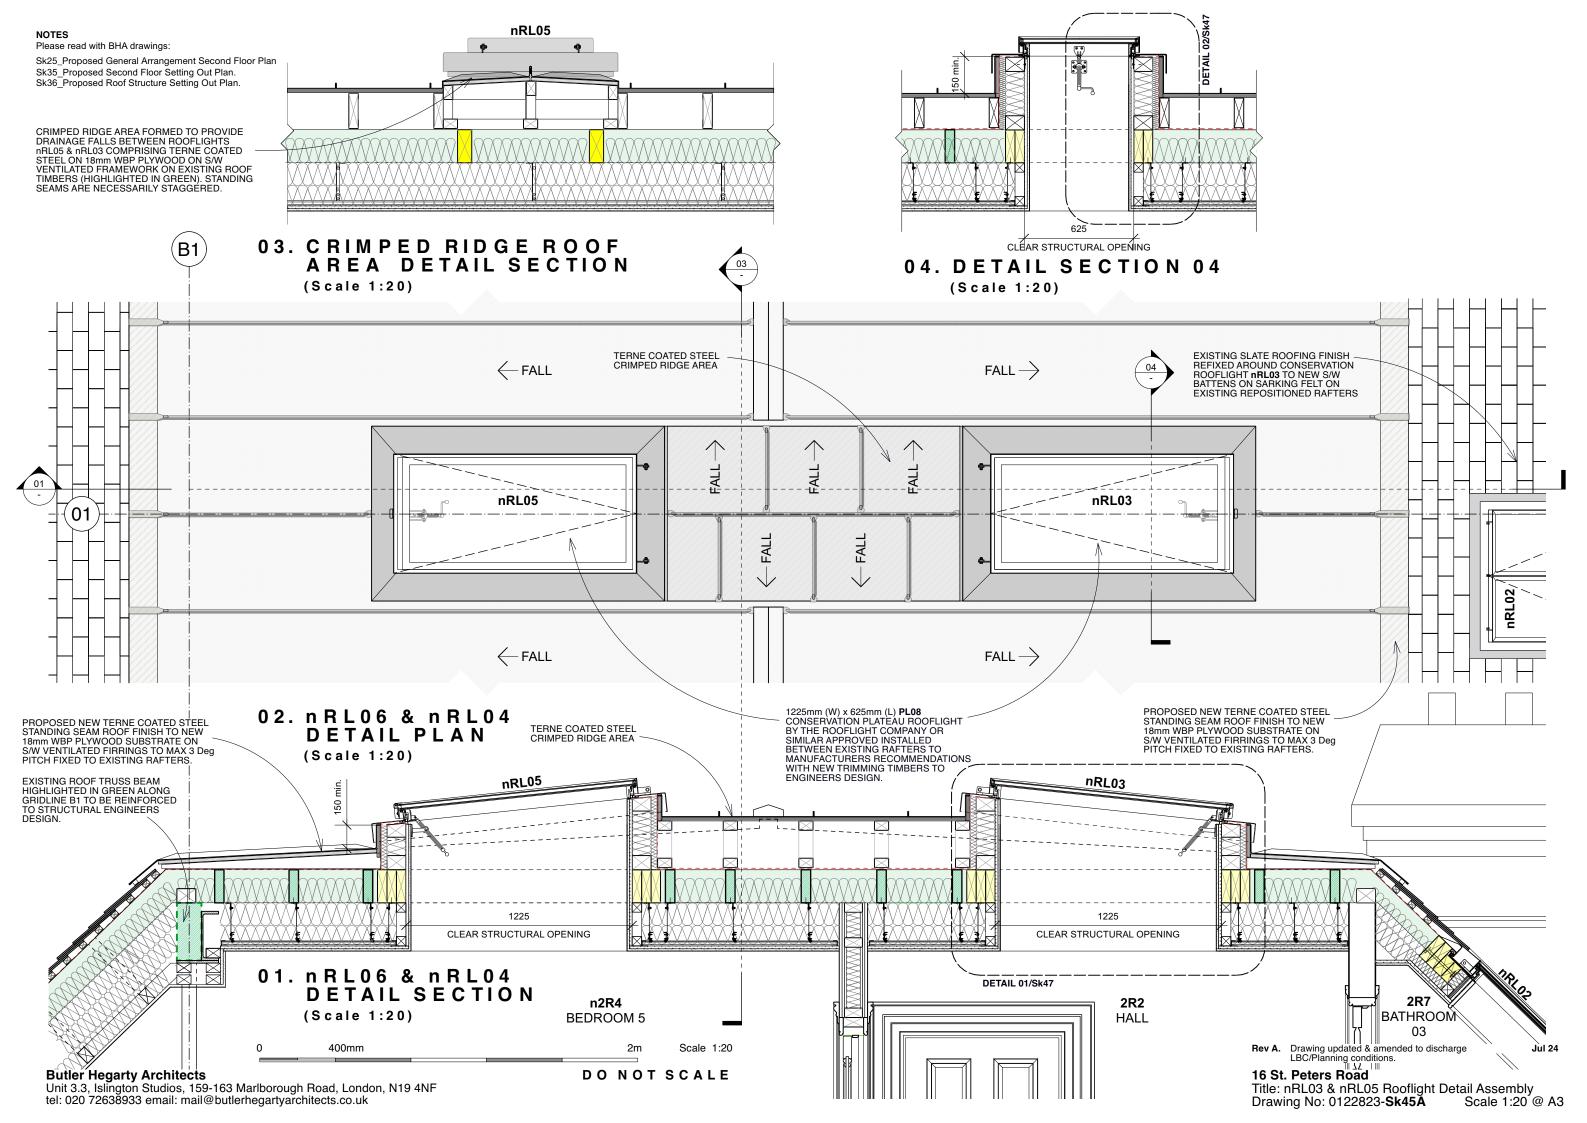

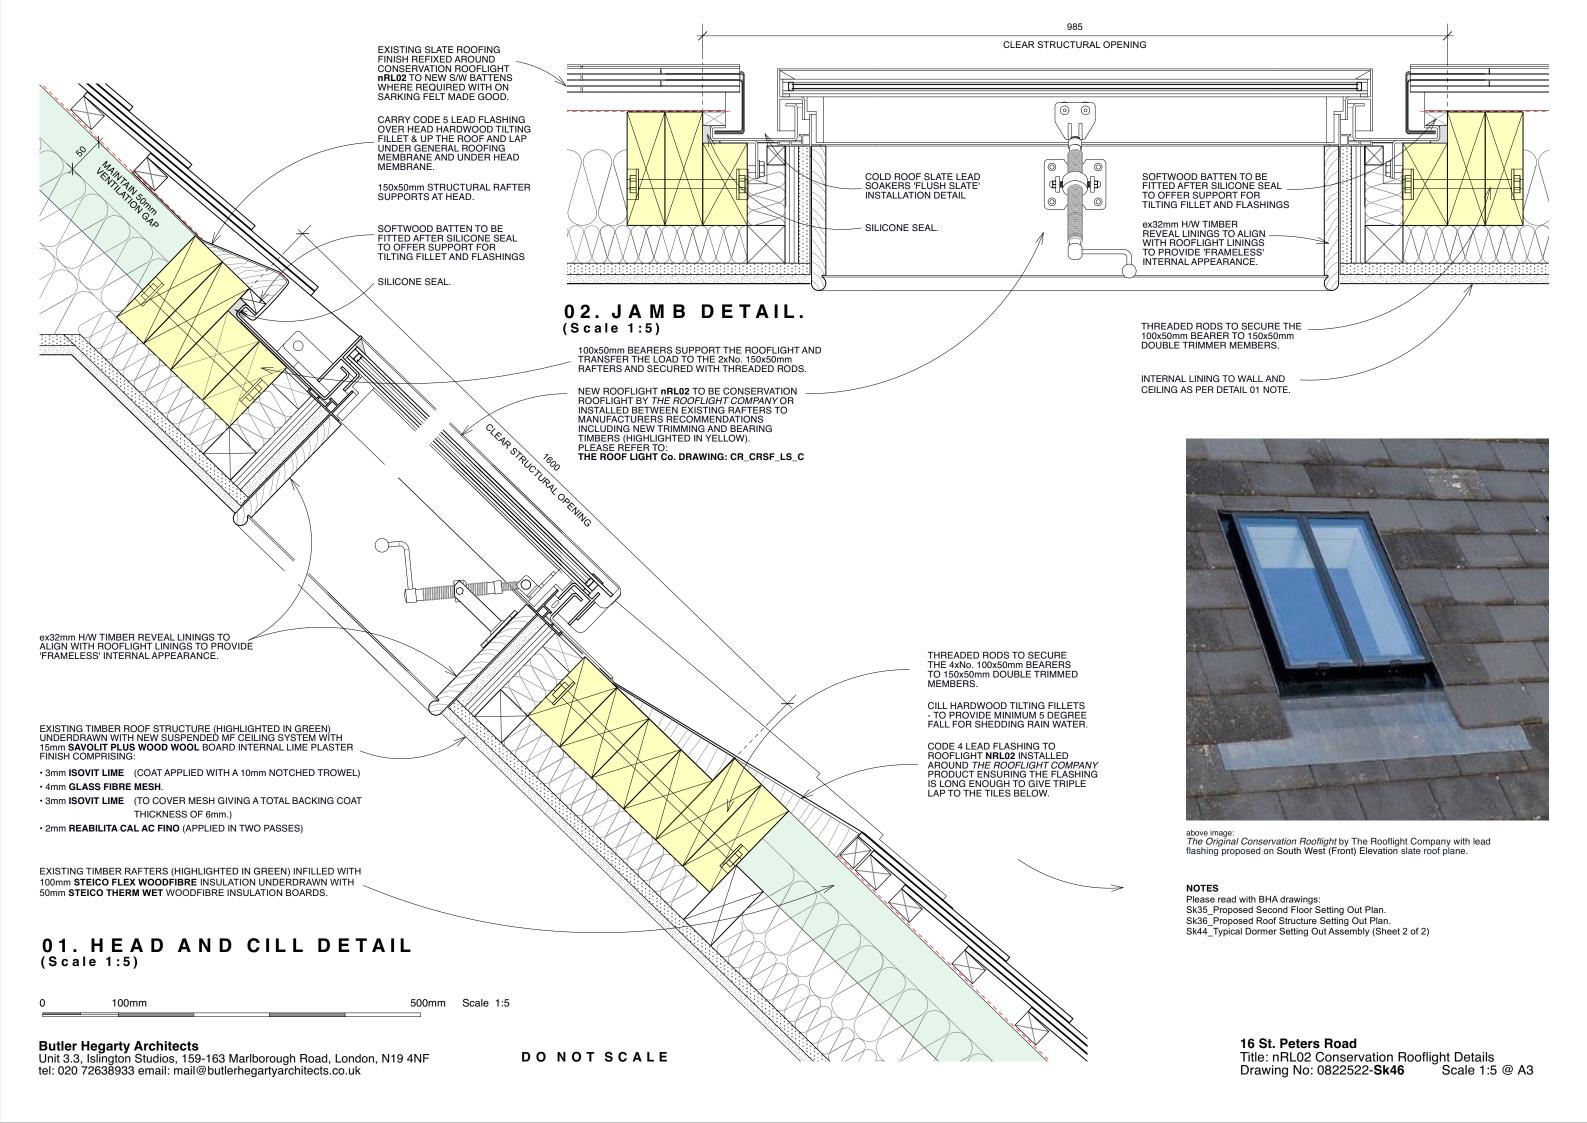

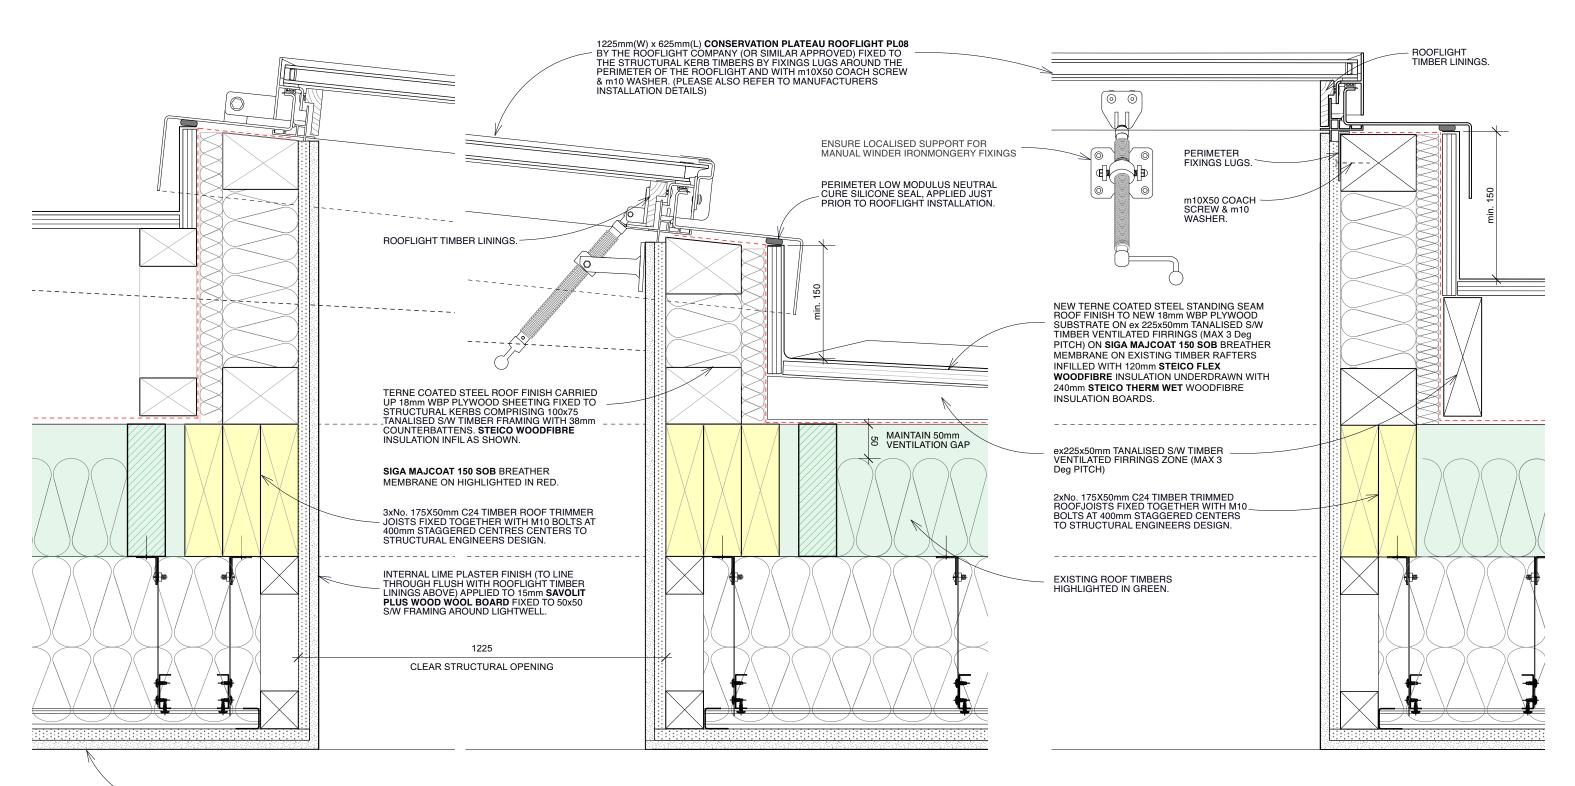

EXISTING TIMBER ROOF STRUCTURE (HIGHLIGHTED IN GREEN) UNDERDRAWN WITH NEW SUSPENDED MF CEILING SYSTEM WITH 15mm SAVOLIT PLUS WOOD WOOL BOARD INTERNAL LIME PLASTER FINISH COMPRISING:

- 3mm ISOVIT LIME (COAT APPLIED WITH A 10mm NOTCHED TROWEL)
- · 4mm GLASS FIBRE MESH.
- 3mm ISOVIT LIME (TO COVER MESH GIVING A TOTAL BACKING COAT THICKNESS OF 6mm.)
- 2mm REABILITA CAL AC FINO (APPLIED IN TWO PASSES)

#### 01. HEAD AND CILL DETAIL (Scale 1:5)

100mm 500mm Scale 1:5

DO NOT SCALE



The Plateau Conservation Rooflight by The Rooflight Company proposed for the existing house new rooflights (Rooflight Ref: nRL03,04,05 & 06)

### 02. SIDE RAIL DETAIL (Scale 1:5)

NOTES
Please read with BHA drawings:
Sk35\_Proposed Second Floor Setting Out Plan.
Sk36\_Proposed Roof Structure Setting Out Plan.
Sk45\_nRL03 & nRL05 Rooflight Detail Assembly

16 St. Peters Road

Title: Typical Plateau Conservation Rooflight Details Drawing No: 0822522-**Sk47** Scale 1:5 @ A Scale 1:5 @ A3