

16 St Peter's Road

Condition Discharge

REFERING TO APPLICATION 22/1754/HOT DECISION NOTICE 1 SEPTEMBER 2022

DETAILED APPLICATION: U0136967

Materials

Prior to the commencement of the development, details, and samples of the materials to be used in the external construction of the works hereby approved, including the proposed extension, dormers roof materials and fenestration shall be submitted to and approved in writing by the Local Planning Authority. Development shall be carried out in accordance with the approved details and retained as such thereafter.

REASON

In order to safeguard the special architectural or historic interest of the grade II listed building and character of the Conservation Area.

Condition Discharge Statement:

The proposed external materials are as follows:

Dormer windows: The dormer roof materials are lead lining to roof and dormer checks with painted timber box sash windows as shown on drawing Sk919 (material palette 01/04). The construction details of the dormer windows are as shown on drawings Sk42 and Sk43.

The roof light: To the main roof of the building are to be plateau conservation roof lights on tern coated stainless steel. The roof light in slate pitched roof will be CI low profile conservation roof light with lead flashings, all as shown on drawing SK920 (material palette 02/04). The construction detail for roof lights is as shown on drawings Sk44, Sk45, Sk46, and Sk47.

New extension: The proposed roof material for the new extension will be a tern coated stainless steel roof with a low profile stainless steel roof light as shown on drawing Sk921 (material palette 03/04). The proposed wall surface of the extension will be painted lime render. The fenestration to the new extension is stainless steel frameless glazing system as shown on drawing Sk922 (material palette 04/04).

Condition Discharge Documents:

LBRUT to revert if actual physical material samples will be required in this instance.

For precedent images confirming proposed materials please refer to BHA detail drawings listed below:

- Sk919_Proposed New External Materials Pallet (1of4) Dormer Roof Materials
- Sk920_Proposed New External Materials Pallet (2of4) Main roof and roof light materials
- Sk921_Proposed New External Materials Pallet (3of4) Extension Roof materials
- Sk922_Proposed New External Materials Pallet (4of4) Elevation materials

For details and location of proposed materials see:

Elevation studies:

- Sk26D_Proposed General Arrangement Roof Plan
- Sk27A Proposed Southwest (Front) Elevation
- Sk28A Proposed Southeast & Northwest (Side) Elevations
- Sk29A Proposed Northeast (Rear) GA Elevation

Extension Wall and fenestration see construction studies:

- Sk30_Main Kitchen Extension Northeast Elevation (1:25)
- Sk31_Main Kitchen Extension Southeast & Southwest Elevation

Dormer window construction details:

- Sk42A_Typical Dormer Setting Out Assembly (Sheet 1 of 2) ٠
- Sk43A_Typical Dormer Setting Out Assembly (Sheet 2 of 2) •

Roof light details:

- Sk44A_Conservation Roof light nRL02 Detail Assembly Sk45A_nRL03 & nRL05 Roof light Detail Assembly Sk46_nRL02 Conservation Roof light Details Sk47_Typical Plateau Roof light Details ٠
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- •







above image: Example of late 19c Victorian dwelling's mansard roof with three dormer windows lead lined cheeks. As per our 16 St Peters proposals the white painted timber box sash windows in this proposals the white painted timber box sash windows in this example comprise one over one fenestration. Additionally, their adjacent white timber lining boards provide a stop to the dormer cheek leadwork on the front face to meet the sash window as per our proposed details on BHA drawing **Sk42**, **Sk43 & Sk48**.



above images: Example from a previous Butler Hegarty Architects project of the proposed leadwork roof and cheeks to be used on the three new 16 St Peters Road dormer windows including This example also shows the proposed corner junction detail between the dormer cheek leadwork and white painted timber lining boards.

PROPOSED PALLET OF LEAD AND WHITE PAINTED TIMBER TO NEW DORMER WINDOWS

Butler Hegarty Architects Unit 3.3, Islington Studios, 159-163 Marlborough Road, London, N19 4NF tel: 020 72638933 email: mail@butlerhegartyarchitects.co.uk

For Details please refer to BHA drawings: Sk42_Typical Dormer Setting Out Assembly (Sheet 1 of 2) Sk43_Typical Dormer Setting Out Assembly (Sheet 2 of 2) Sk48_Typical Dormer Roof Details

For General Arrangement Location: Sk26_Proposed General Arrangement Roof Plan Sk28_Proposed South East & North West (Side) Elevations Sk29_Proposed North East (Rear) GA Elevation

16 St. Peters RoadTitle: Proposed New External Materials Pallet (1of4)Drawing No: 0822522-Sk919Scale: nts @ A3









above images: Examples of *The Original Conservation Rooflight* by The Rooflight Company with lead flashing proposed on South West (Front) Elevation (Rooflight Ref: nRL02) for the second floor Bathroom 2R7 and installed to manufactures recommendations to finish flush with the existing pitched slate roof. endations

above images: Examples of *The Plateau Conservation Rooflight* by The Rooflight Company proposed for the existing house new rooflights **(Rooflight Ref: nRL03,04,05 & 06)** and installed to manufactures recommendations on the proposed new Terne Coated Stainless Steel hipped roof cover.


PROPOSED NEW CONSERVATION ROOFLIGHTS TO EXISTING HOUSE MAIN ROOF REFURBISHMENT.


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For Details please refer to BHA drawings: Sk44_Conservation Rooflight nRL03 Detail Assembly Sk45_nRL06 & nRL04 Rooflight Detail Assembly Sk46_nRL02 Conservation Rooflight Details Sk47_Typical Plateau Rooflight Details

For General Arrangement Location: Sk26_Proposed General Arrangement Roof Plan Sk27_Proposed South West (Front) Elevation Sk28_Proposed South East & North West (Side) Elevations Sk29_Proposed North East (Rear) GA Elevation

16 St. Peters RoadTitle: Proposed New External Materials Pallet (2of4)Drawing No: 0822522-Sk920Scale: nts @ A3



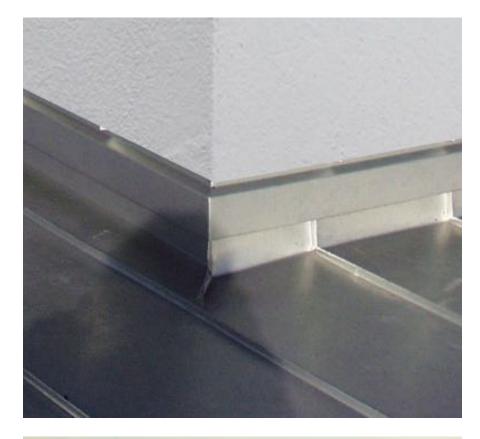

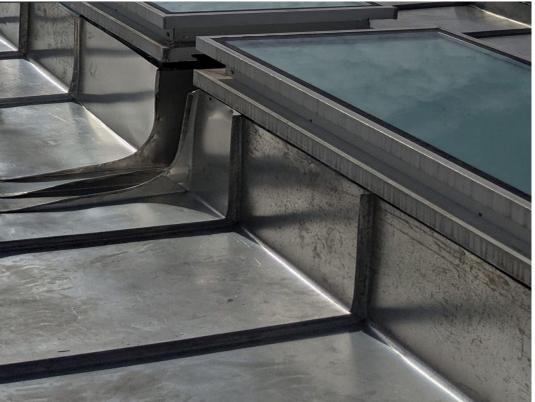



Above image: Example of Terne Coated Stainless Steel parapet, (with folded seams), as proposed to cap the 16 St Peters Road new build side extension's white painted lime render walls.

Top image: Example of Terne Coated Stainless Steel abutment detail to white painted lime render wall proposed for junction between new side extension roof and existing house's side elevation.

Above image: Example of Terne Coated Stainless Steel concealed gutter parapet, (with folded seams), over white painted render wall as proposed on the new build side extension roof.

Top image: Example of Terne Coated Stainless Steel upstand detail to rooflight as proposed on the new build side extension roof.

TERNE COATED STAINLESS STEEL STANDING SEAM ROOFING MATERIAL PROPOSED FOR NEW SIDE EXTENSION AND MAIN HOUSE ROOF REFURBISHMENT.

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For Details please refer to BHA drawings: Sk80_Main Kitchen Extension Longitudinal Section X-X Sk81_Main Kitchen Extension Cross Section Y-Y Sk82_Main Kitchen Extension Roof Structure & Roof Plan Sk83_Main Kitchen Extension Roof Details (Sheet 1of2) Sk84_Main Kitchen Extension Roof Details (Sheet 2of2)

For General Arrangement Location: Sk30_Main Kitchen Extension North East Elevation Sk31_Main Kitchen Extension South East & South West Elevation

16 St. Peters Road Title: Proposed New External Materials Pallet (3of4). Drawing No: 0822522-**Sk921** Scale: nts @ A3









Above image: Close up detail of Sky-Frame Classic brushed stainless steel frameless glazed sliding door system set within a newbuild white lime rendered modern building as proposed on the rear garden elevation of the new extension.

Top image: Sky-Frame Classic example with three panel fenestration arrangement behind frameless glazed balustrade with brushed stainless steel terrace edge cover plate.

PROPOSED PALLET OF WHITE PAINTED LIME RENDER AND BRUSHED ALUMINIUM FRAMELESS GLAZED SLIDING DOORS TO NEW EXTENSION.

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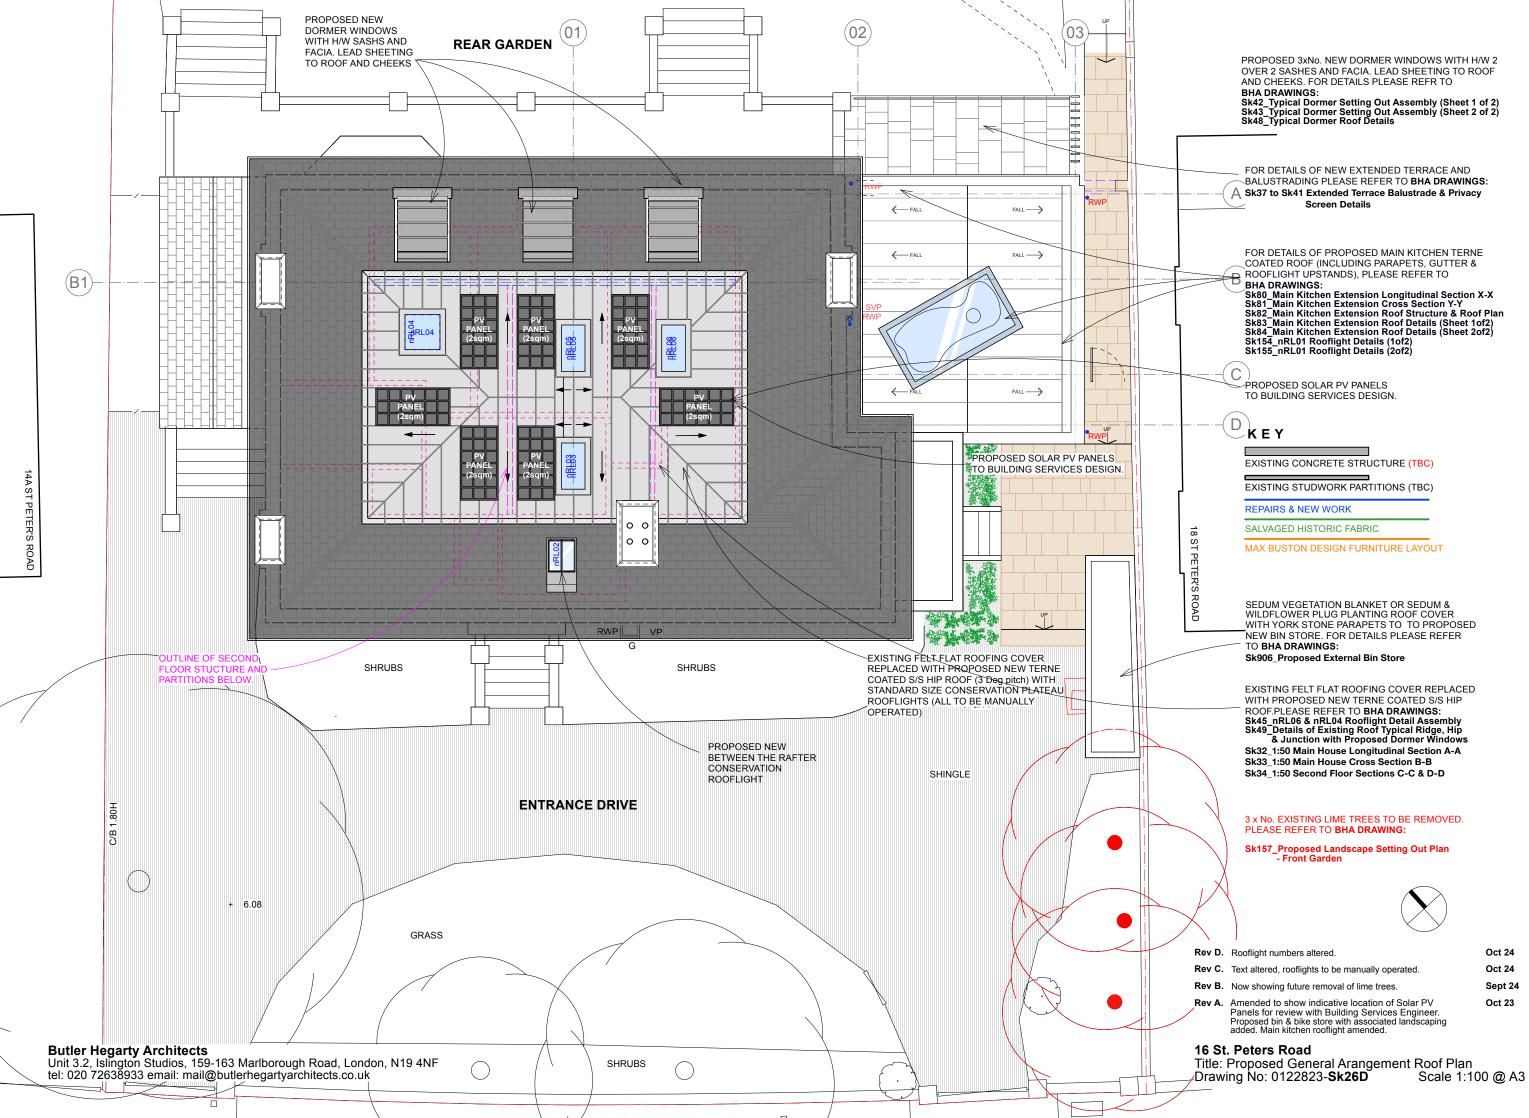
Above image: Example from a single storey modern extension with the same materiality of white painted lime rendered and Terne Coated Stainless Steel parapet copping.


Top image: Further example of Sky-Frame Classic sliding door system set within a newbuild white single storey rendered modern extension with a folded metal parapet coping.

For Details please refer to BHA drawings: Sk80_Main Kitchen Extension Longitudinal Section X-X Sk80_Main Kitchen Extension Longitudinal Section X-X Sk81_Main Kitchen Extension Cross Section Y-Y Sk83_Main Kitchen Extension Roof Details (Sheet 1of2) Sk84_Main Kitchen Extension Roof Details (Sheet 2of2) Sk37_Extended Terrace Balustrade & Privacy Screen Details (Sheet 1of4) Sk38_Extended Terrace Balustrade & Privacy Screen Details (Sheet 2of4) Sk40_Extended Terrace Balustrade & Privacy Screen Details (Sheet 3of4) Sk40_Extended Terrace Balustrade & Privacy Screen Details (Sheet 4of4) Sk40_Extended Terrace Balustrade & Privacy Screen Details (Sheet 4of4) Sk146_nDG05 Frameless Glazed Sliding Door Details (1of2) Sk147_nDG05 Frameless Glazed Sliding Door Details (2of2)

For General Arrangement Location: Sk30_Main Kitchen Extension North East Elevation Sk31_Main Kitchen Extension South East & South West Elevation

16 St. Peters Road Title: Proposed New External Materials Pallet (4of4). Drawing No: 0822522-**Sk922** Scale: nts @ A3



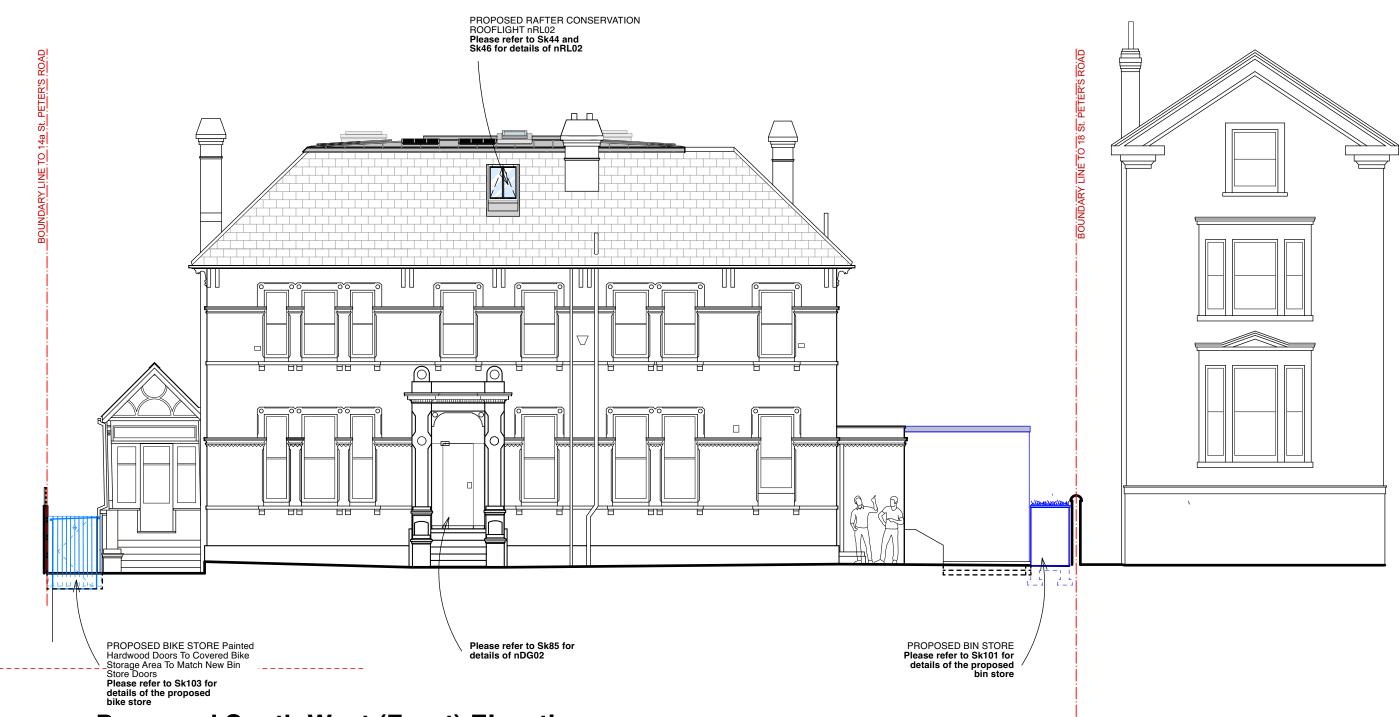

Proposed South West (Front) Elevation



Oct 24

16 St. Peters RoadTitle: Proposed South West (Front) ElevationDrawing No: 0122823-Sk27AScale 1:100 @ A3



Proposed South East (Side) Elevation

Proposed North West (Side) Elevation


0 2m

10m 1:100

Rev A. Alterations shown in blue

Oct 24

16 St. Peters RoadTitle: Proposed South East & North West (Side) ElevationsDrawing No: 0122823-Sk28AScale 1:100 @ A3

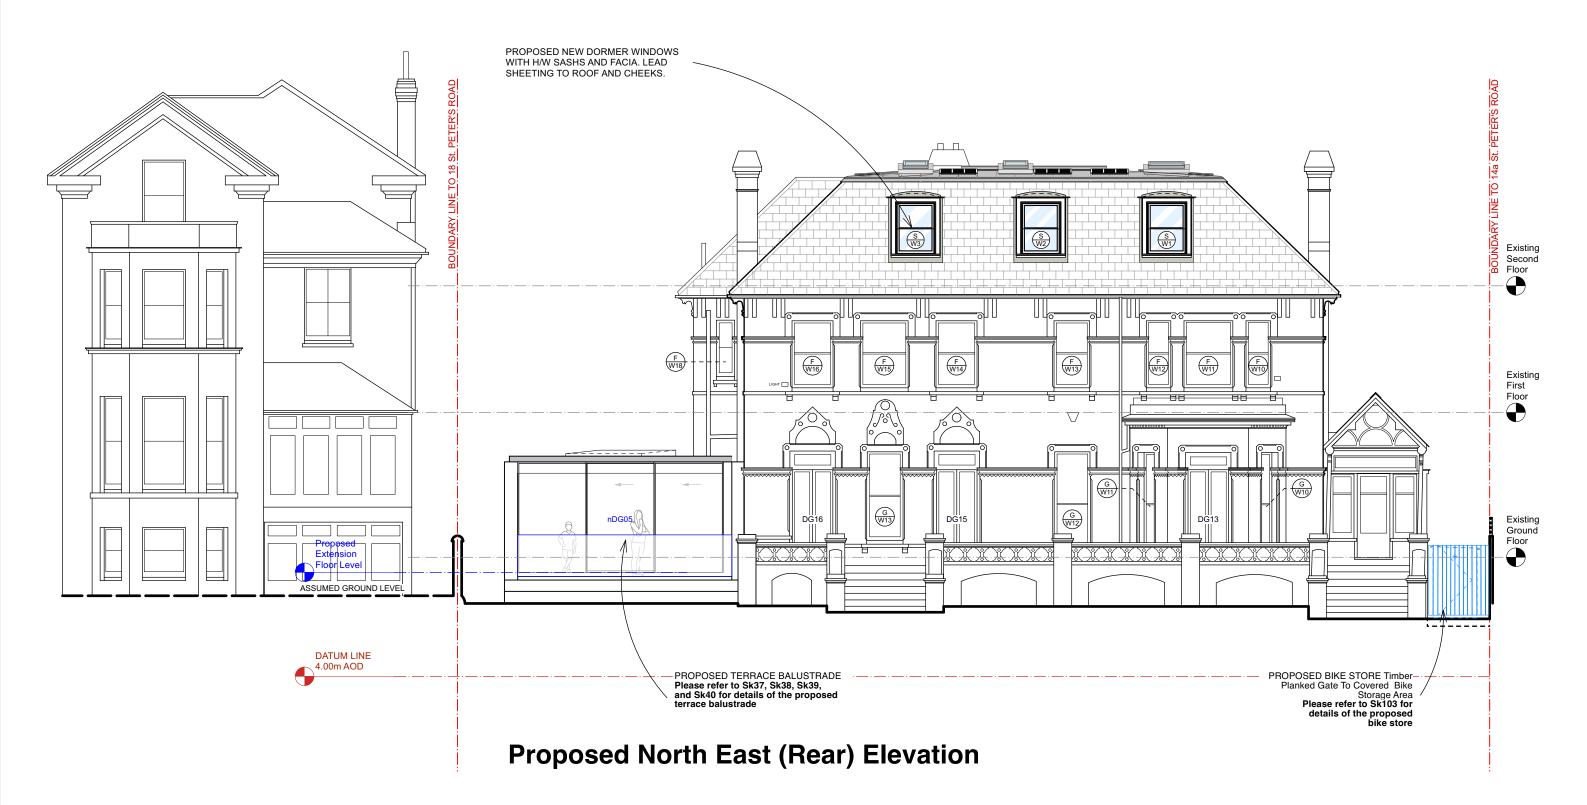


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0 2m

Oct 24

16 St. Peters Road Title: Proposed North East (Rear) GA Elevation Drawing No: 0122823-**Sk29A** Scale 1:100 @ A3

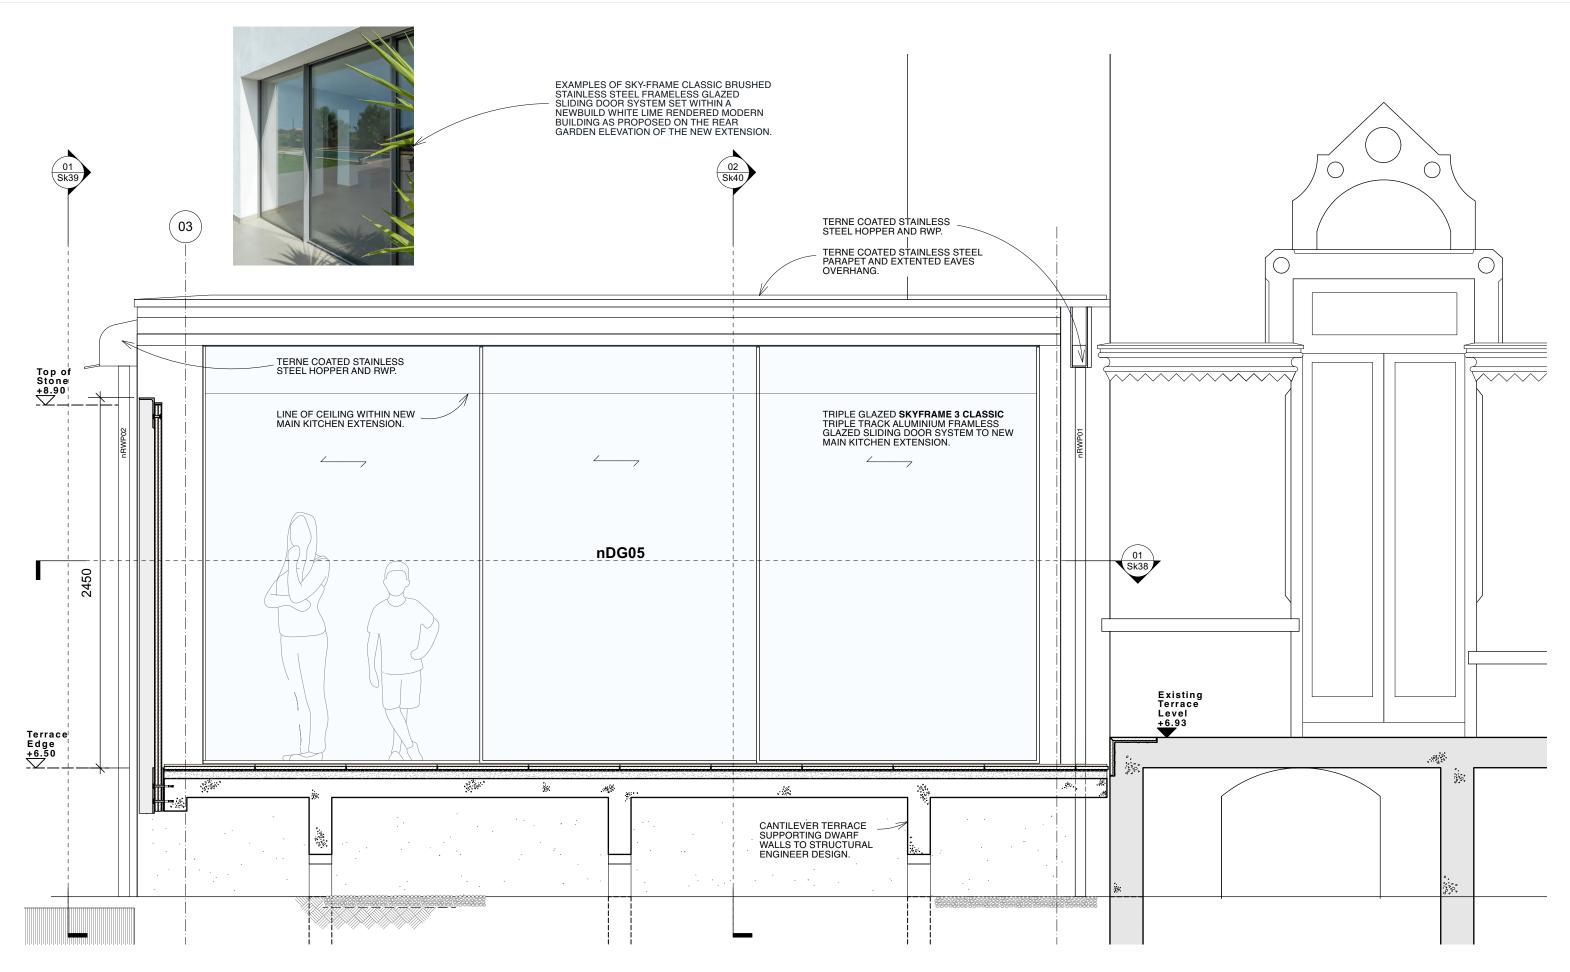


01. MAIN KITCHEN EXTENSION NORTH EAST ELEVATION (Scale 1:25)

To be read in conjunction with BHA Drawings Sk38, Sk39 and Sk40

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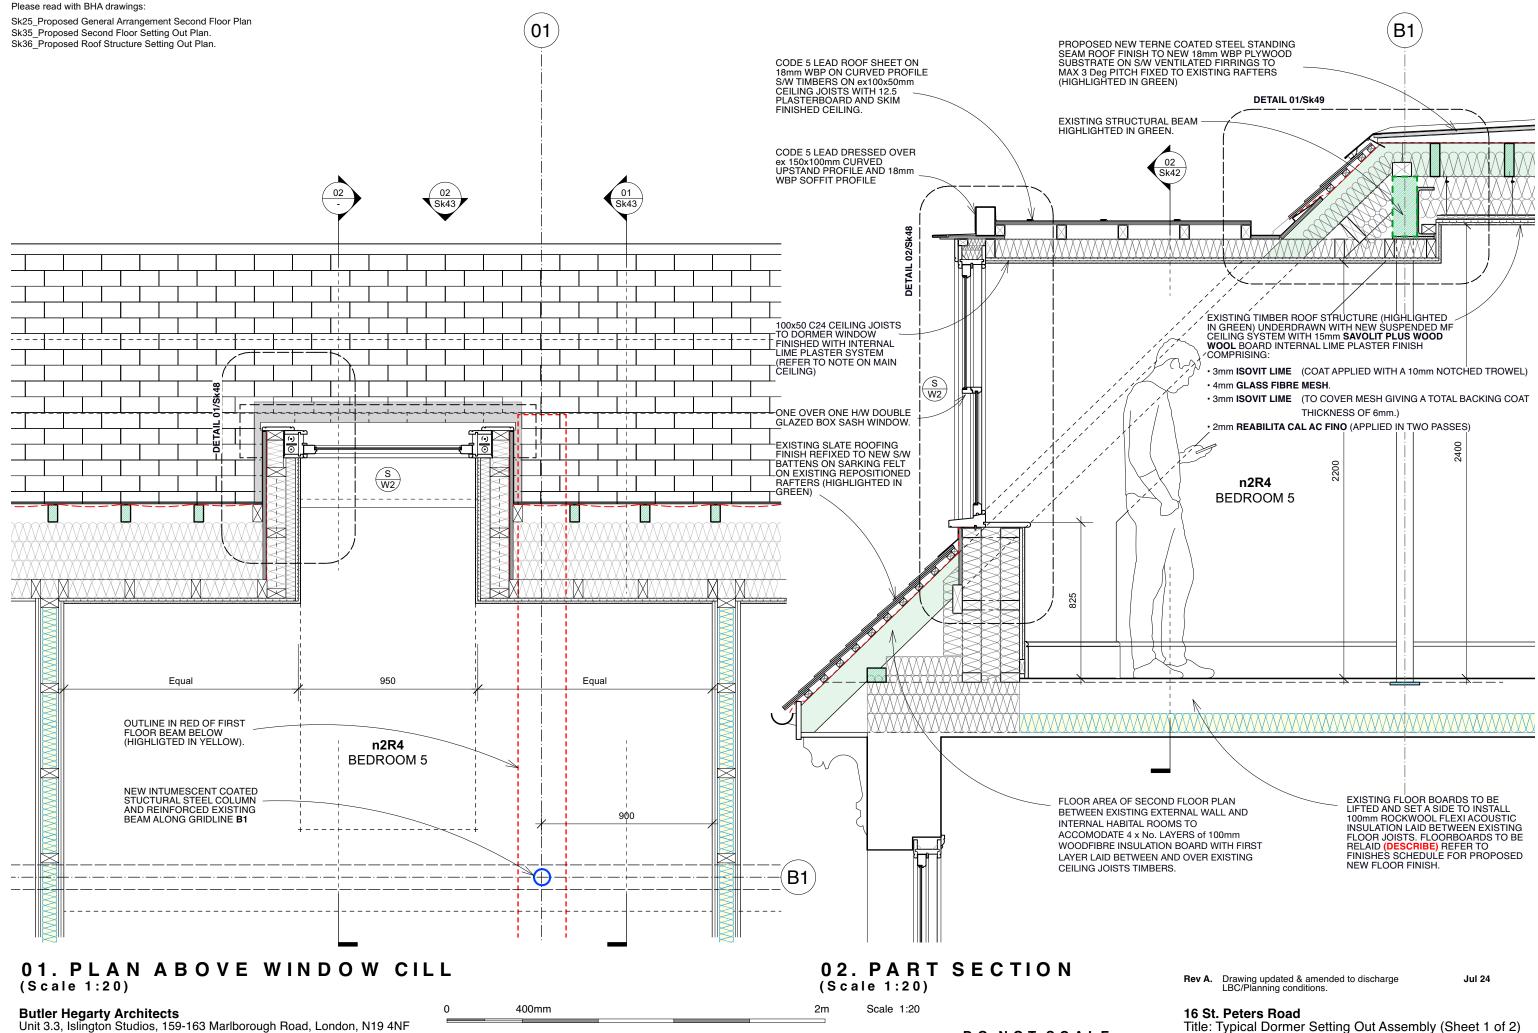
500mm 2500mm Ω

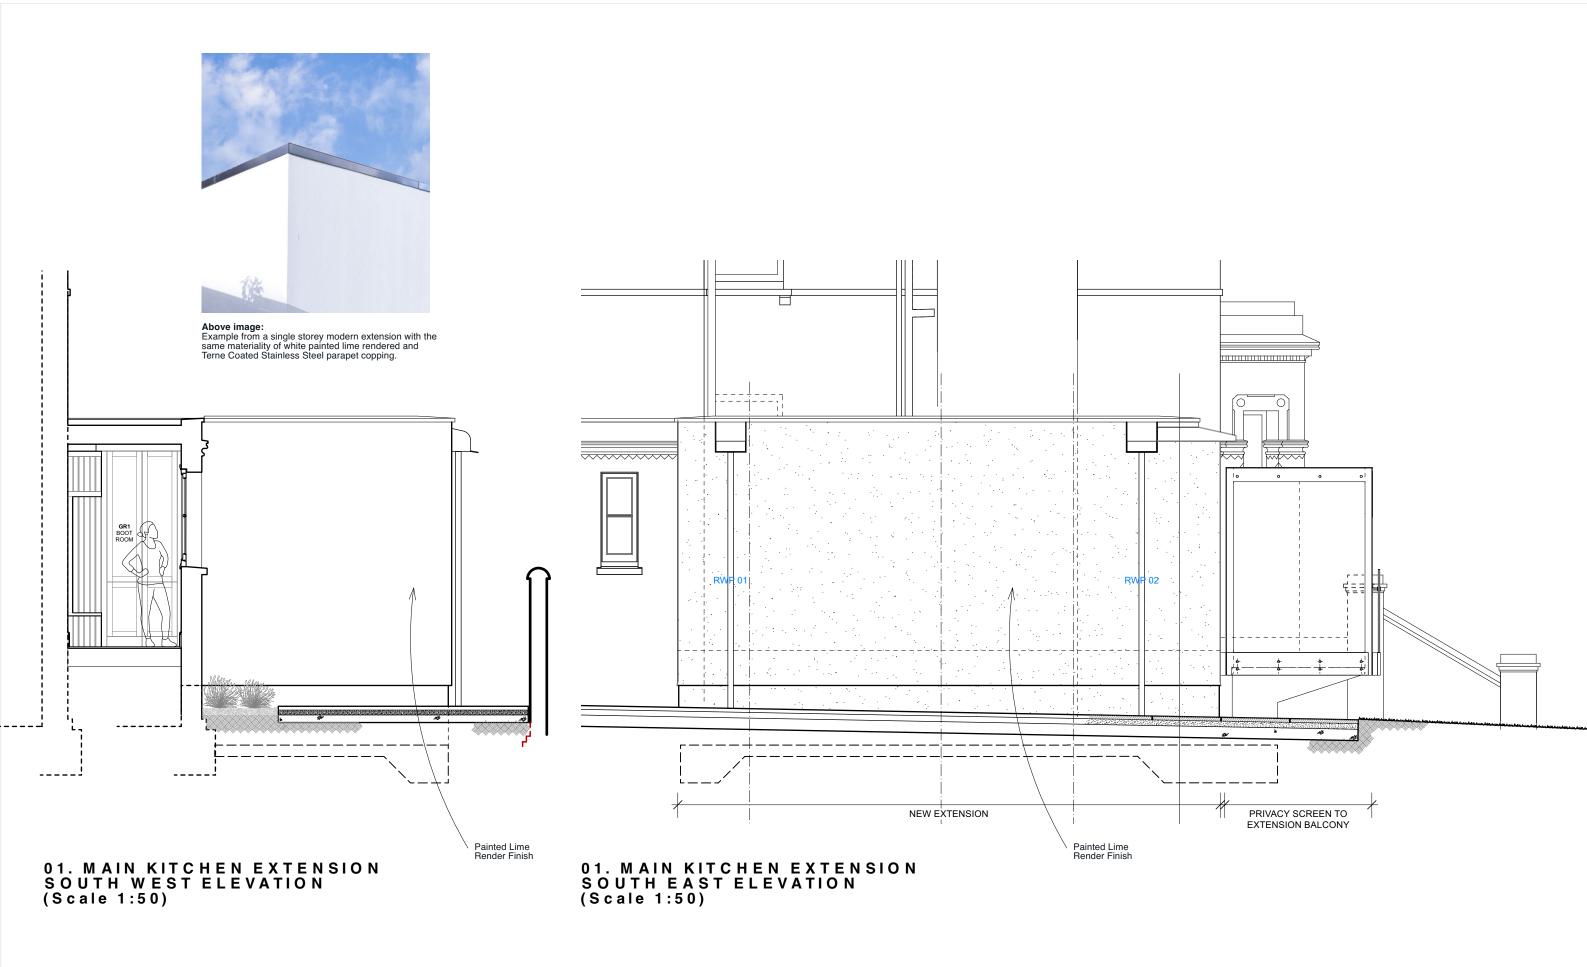

1m 5m

Scale 1:50


16 St. Peters Road Title: Main Kitchen Extension South East & South West Elevations Drawing No: 0122823-**Sk31** Scale 1:50 @ A3



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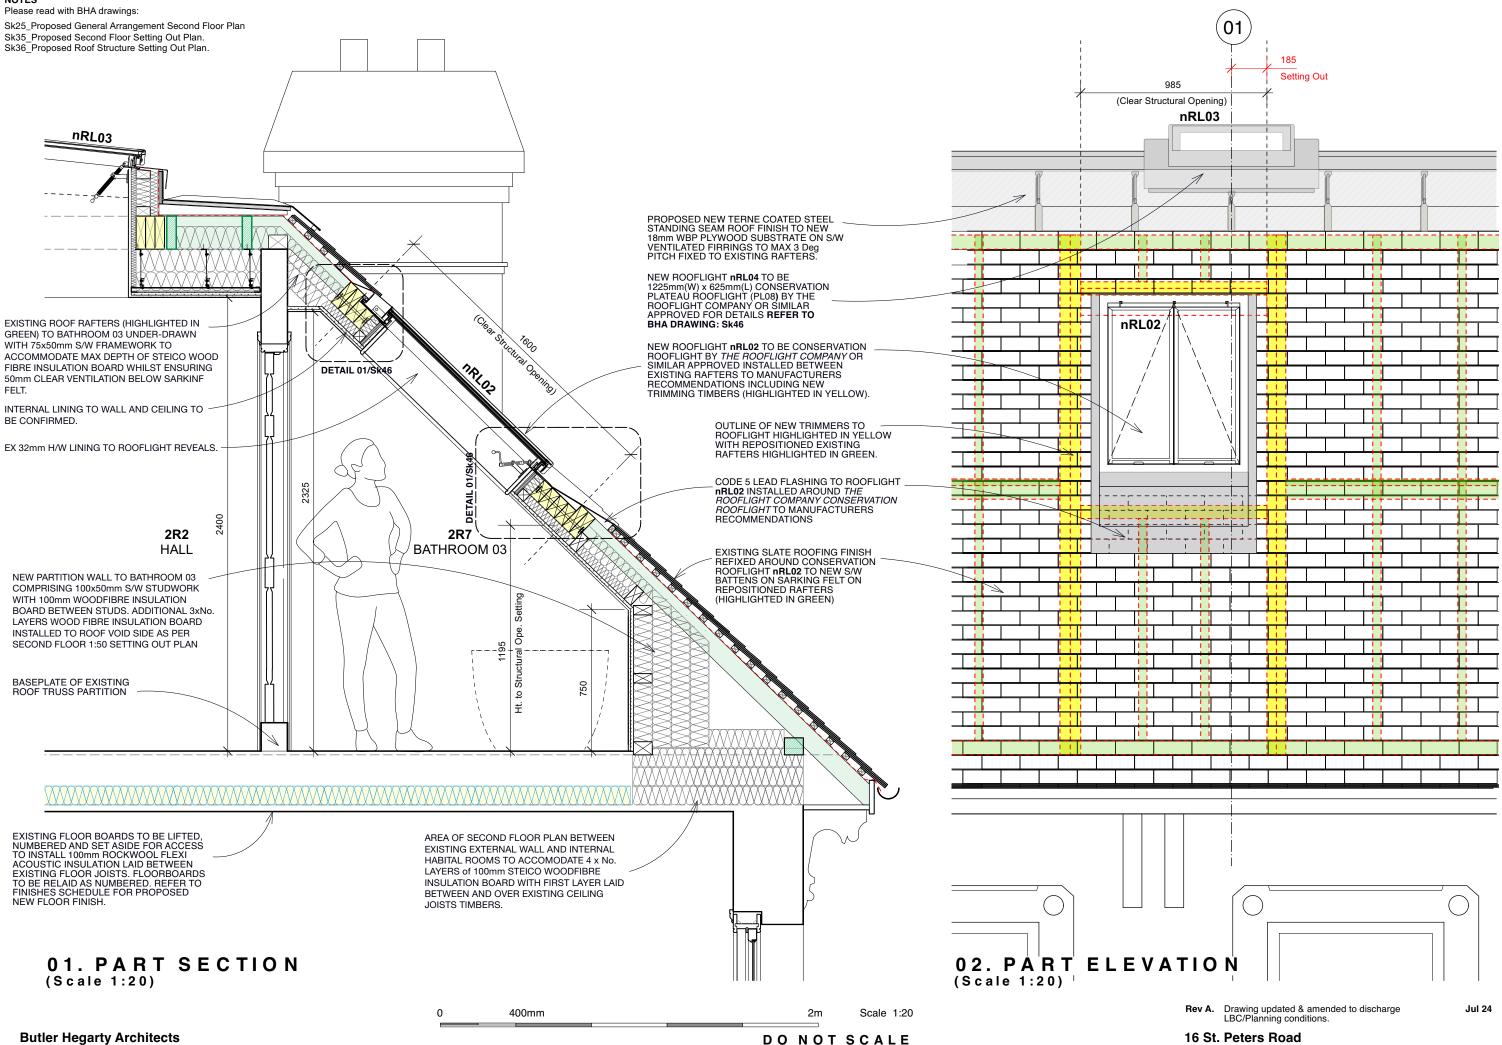
NOTES

Title: Typical Dormer Setting Out Assembly (Sheet 1 of 2) Drawing No: 0122823-Sk42A Scale 1:20 @ A3

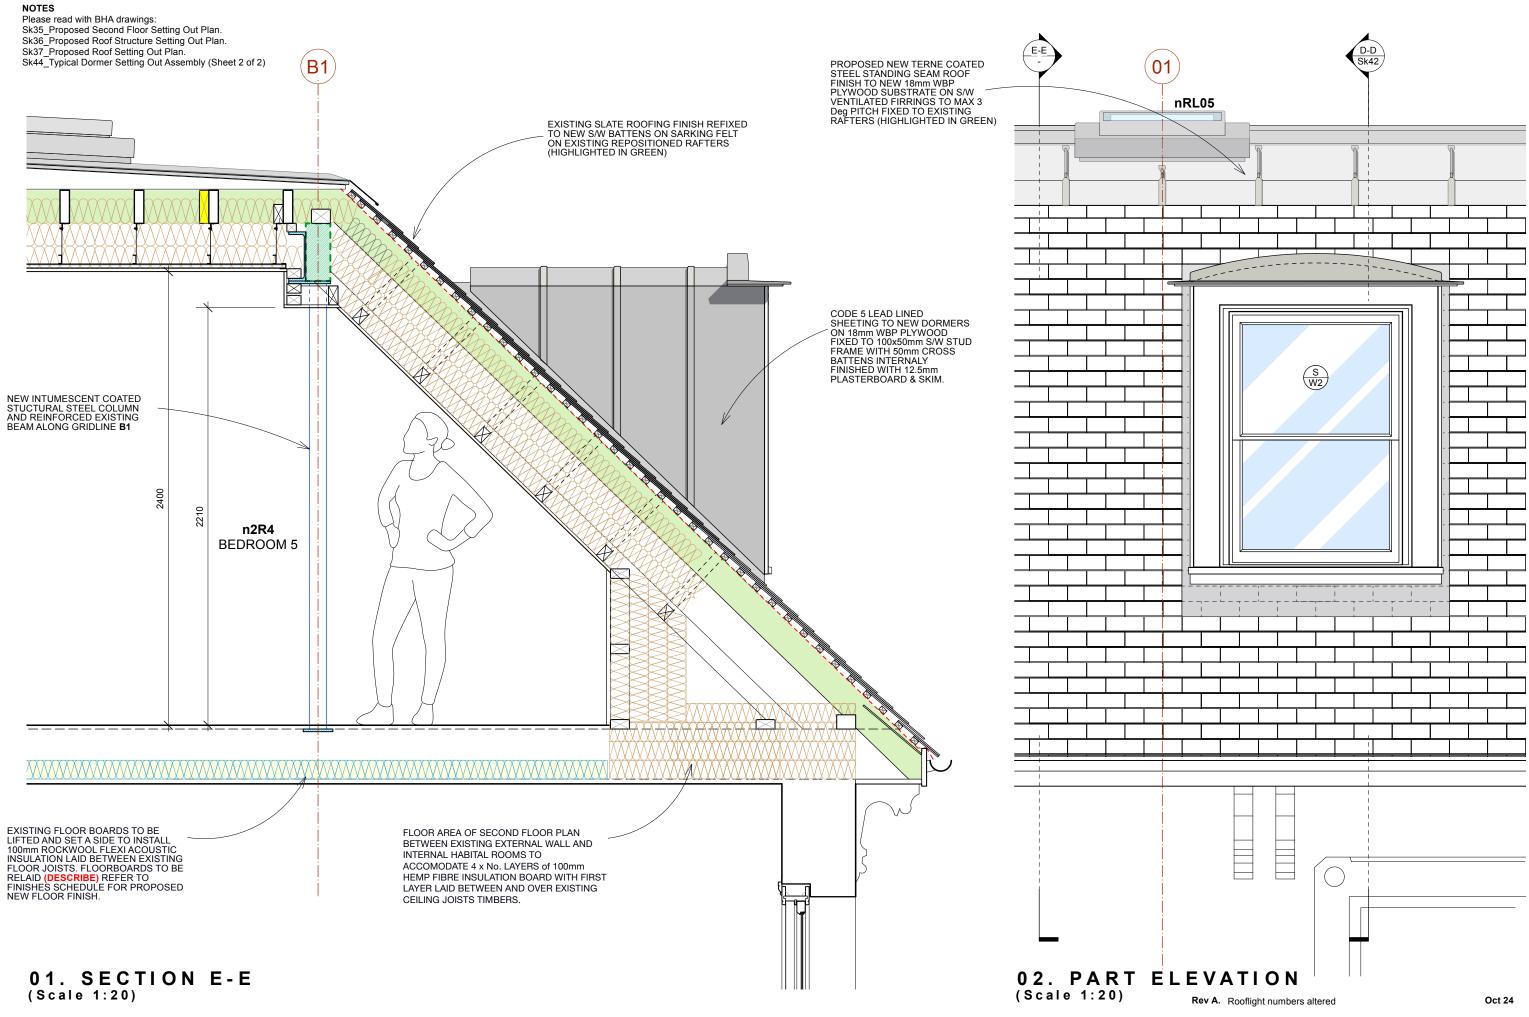


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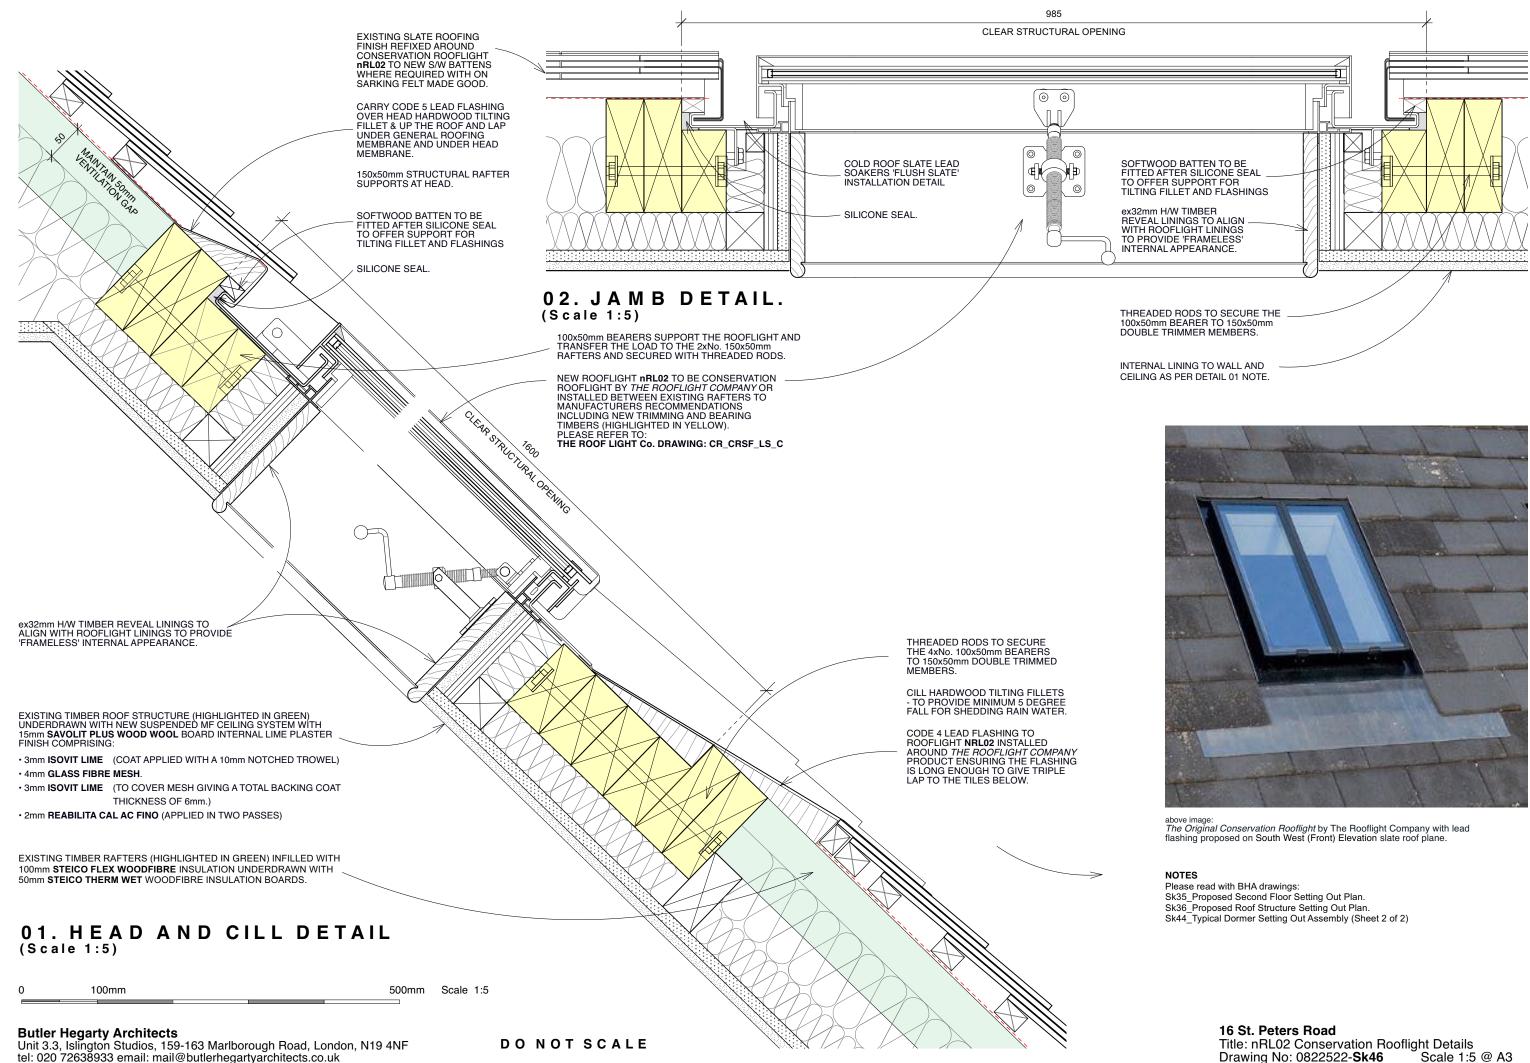
16 St. Peters Road Title: Typical Dormer Setting Out Assembly (Sheet 2 of 2) Drawing No: 0122823-**Sk43A** Scale 1:20 @ A3




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Title: Conservation Rooflight nRL02 Detail Assembly. Drawing No: 0122823-**Sk44A** Scale 1:20 @ A3



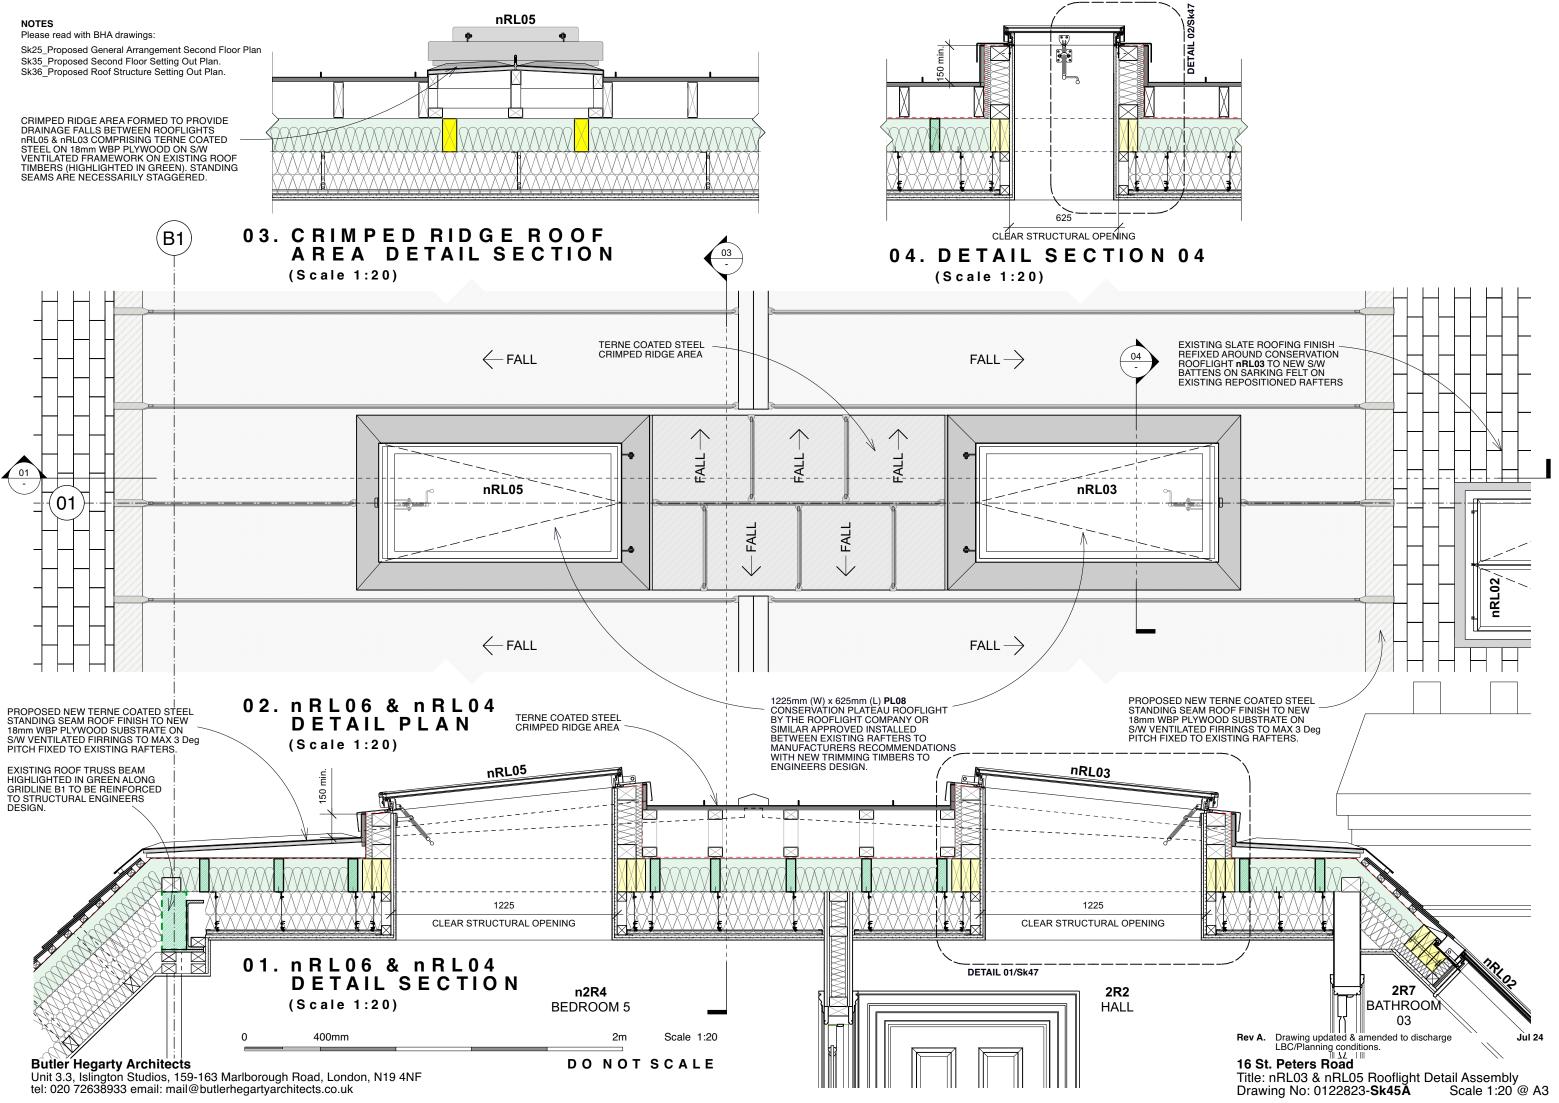

Title: nRL02 Conservation Rooflight Details Drawing No: 0822522-**Sk46** Scale 1:5 Scale 1:5 @ A3

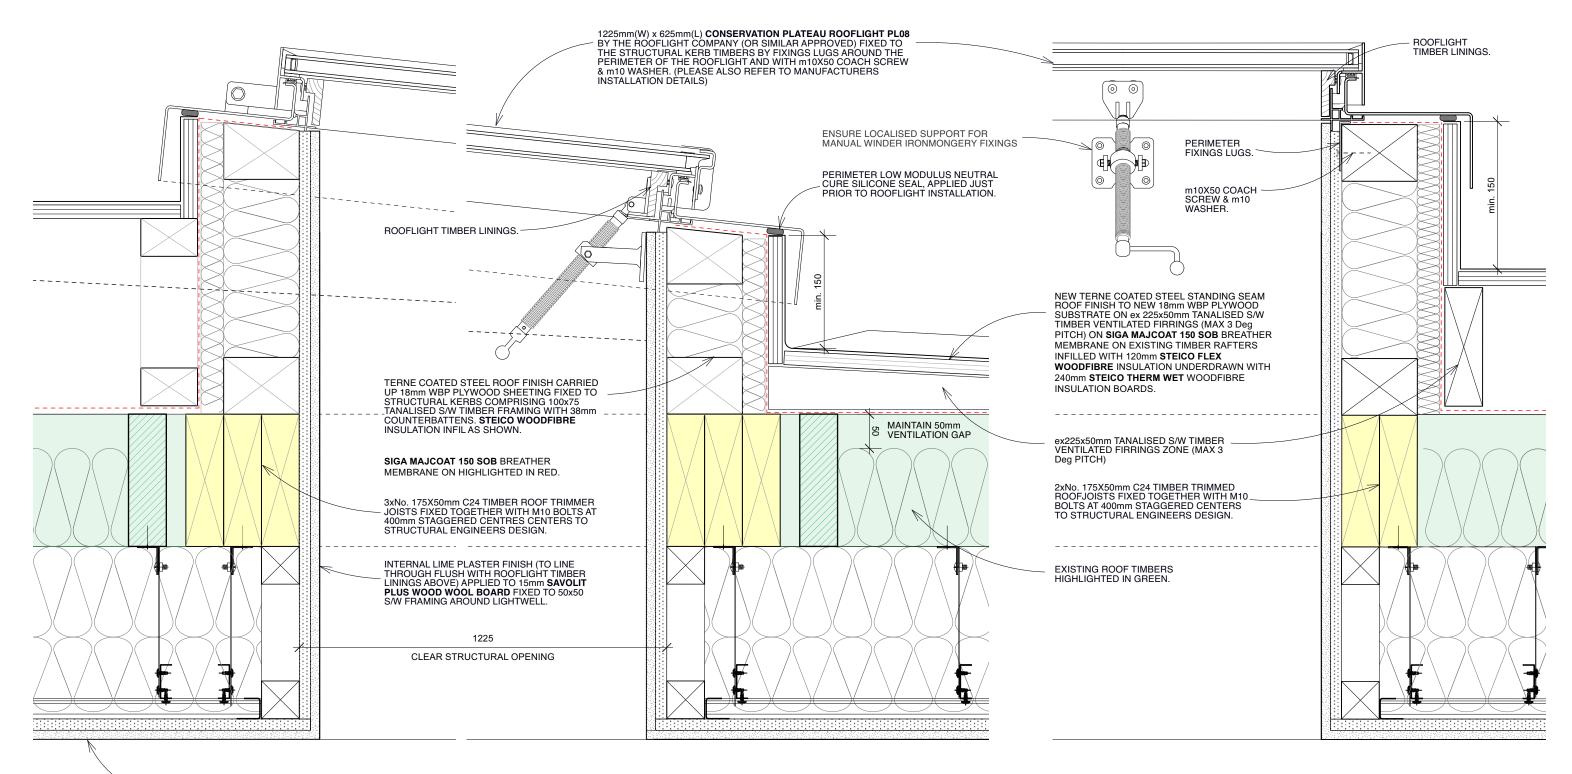

- EXISTING TIMBER ROOF STRUCTURE (HIGHLIGHTED IN GREEN) UNDERDRAWN WITH NEW SUSPENDED MF CEILING SYSTEM WITH 15mm SAVOLIT PLUS WOOD WOOL BOARD INTERNAL LIME PLASTER FINISH COMPRISING:
- 3mm ISOVIT LIME (COAT APPLIED WITH A 10mm NOTCHED TROWEL) · 4mm GLASS FIBRE MESH.
- 3mm ISOVIT LIME (TO COVER MESH GIVING A TOTAL BACKING COAT THICKNESS OF 6mm.)
- · 2mm REABILITA CAL AC FINO (APPLIED IN TWO PASSES)

01. HEAD AND CILL DETAIL (Scale 1:5)

100mm

0

500mm Scale 1:5

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The Plateau Conservation Rooflight by The Rooflight Company proposed for the existing house new rooflights (Rooflight Ref: nRL03,04,05 & 06)

(Scale 1:5)

DO NOT SCALE

02. SIDE RAIL DETAIL

NOTES

Please read with BHA drawings: Sk35_Proposed Second Floor Setting Out Plan. Sk36_Proposed Roof Structure Setting Out Plan. Sk45_nRL03 & nRL05 Rooflight Detail Assembly

16 St. Peters Road Title: Typical Plateau Conservation Rooflight Details Drawing No: 0822522-**Sk47** Scale 1:5 @ A Scale 1:5 @ A3