


16 St. Peters Road
Title: Proposed 2nd Floor Door Type B Details
(nDS05 Jib Door to n2R6 Ensuite)
Drawing No: 0122823-Sk132 Scale 1:10 & 1:2 @ A3

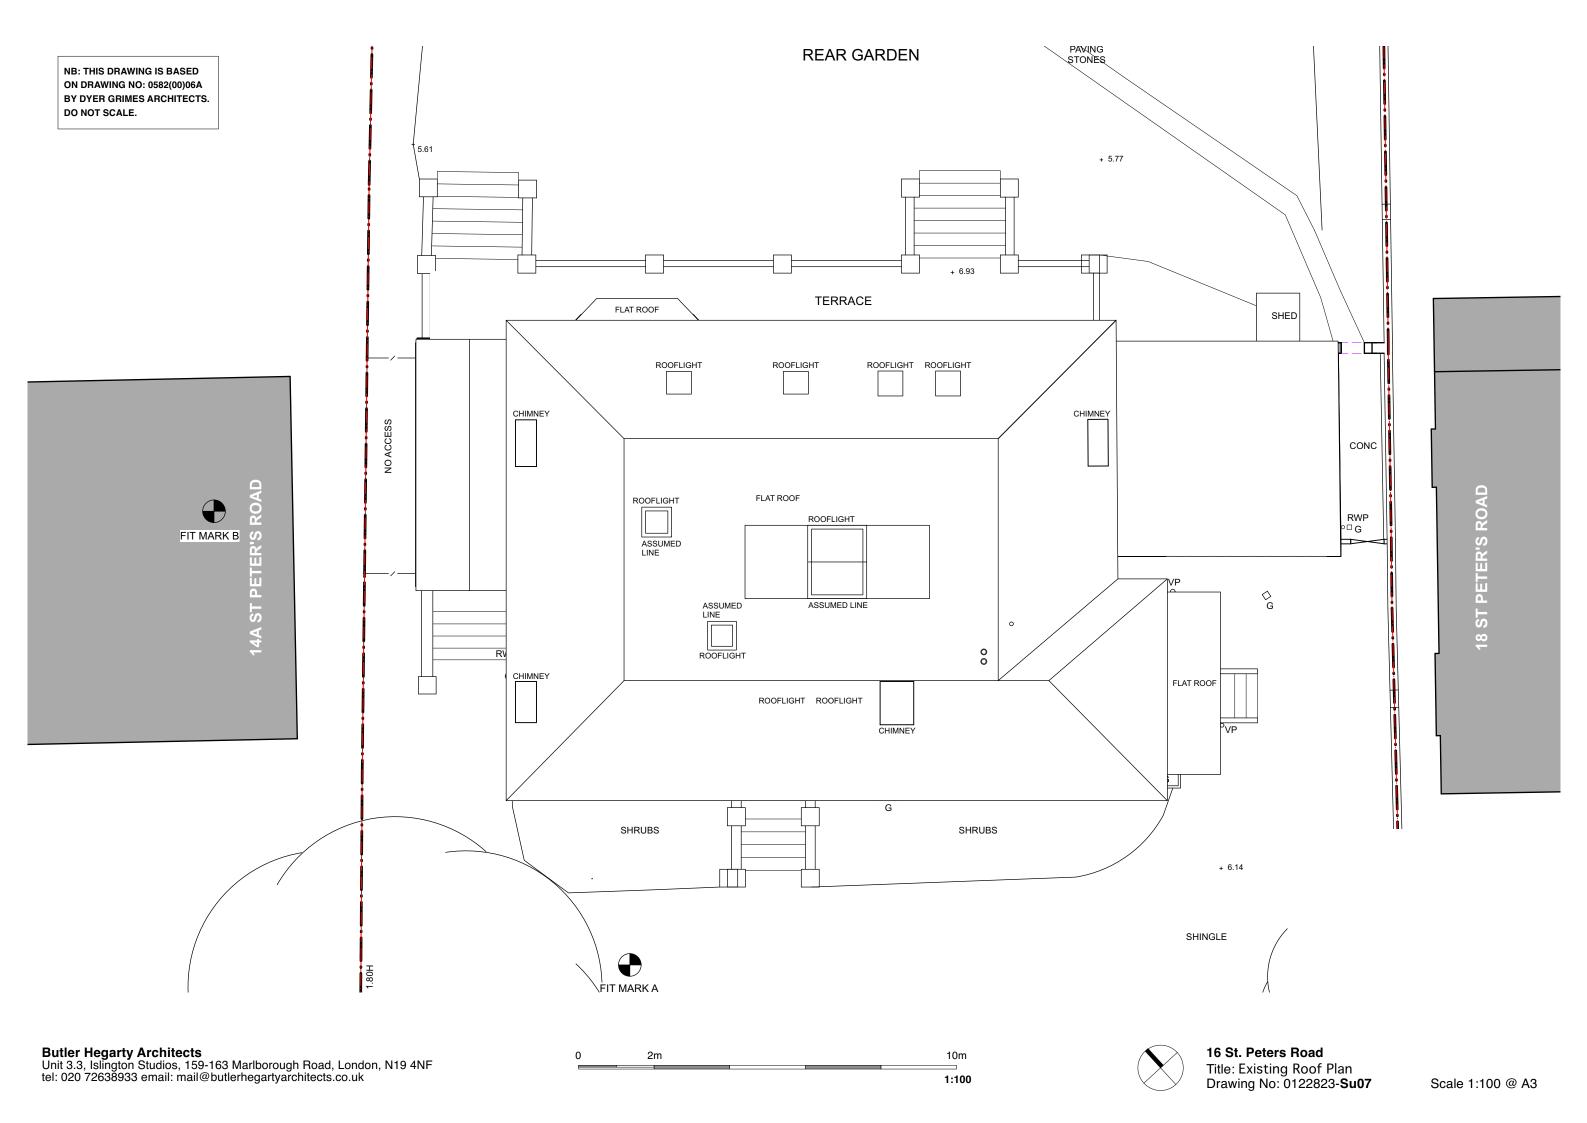



03. Existing Service Vent Pipes (Feburary 2023)



01. Existing Roof looking towards 14a St Peters Road (Feburary 2023)







04. Existing Rear Elevation from Younique Gardens (Feburary 2023)



02.Existing Roof looking towards 18 St Peters Road (Feburary 2023)

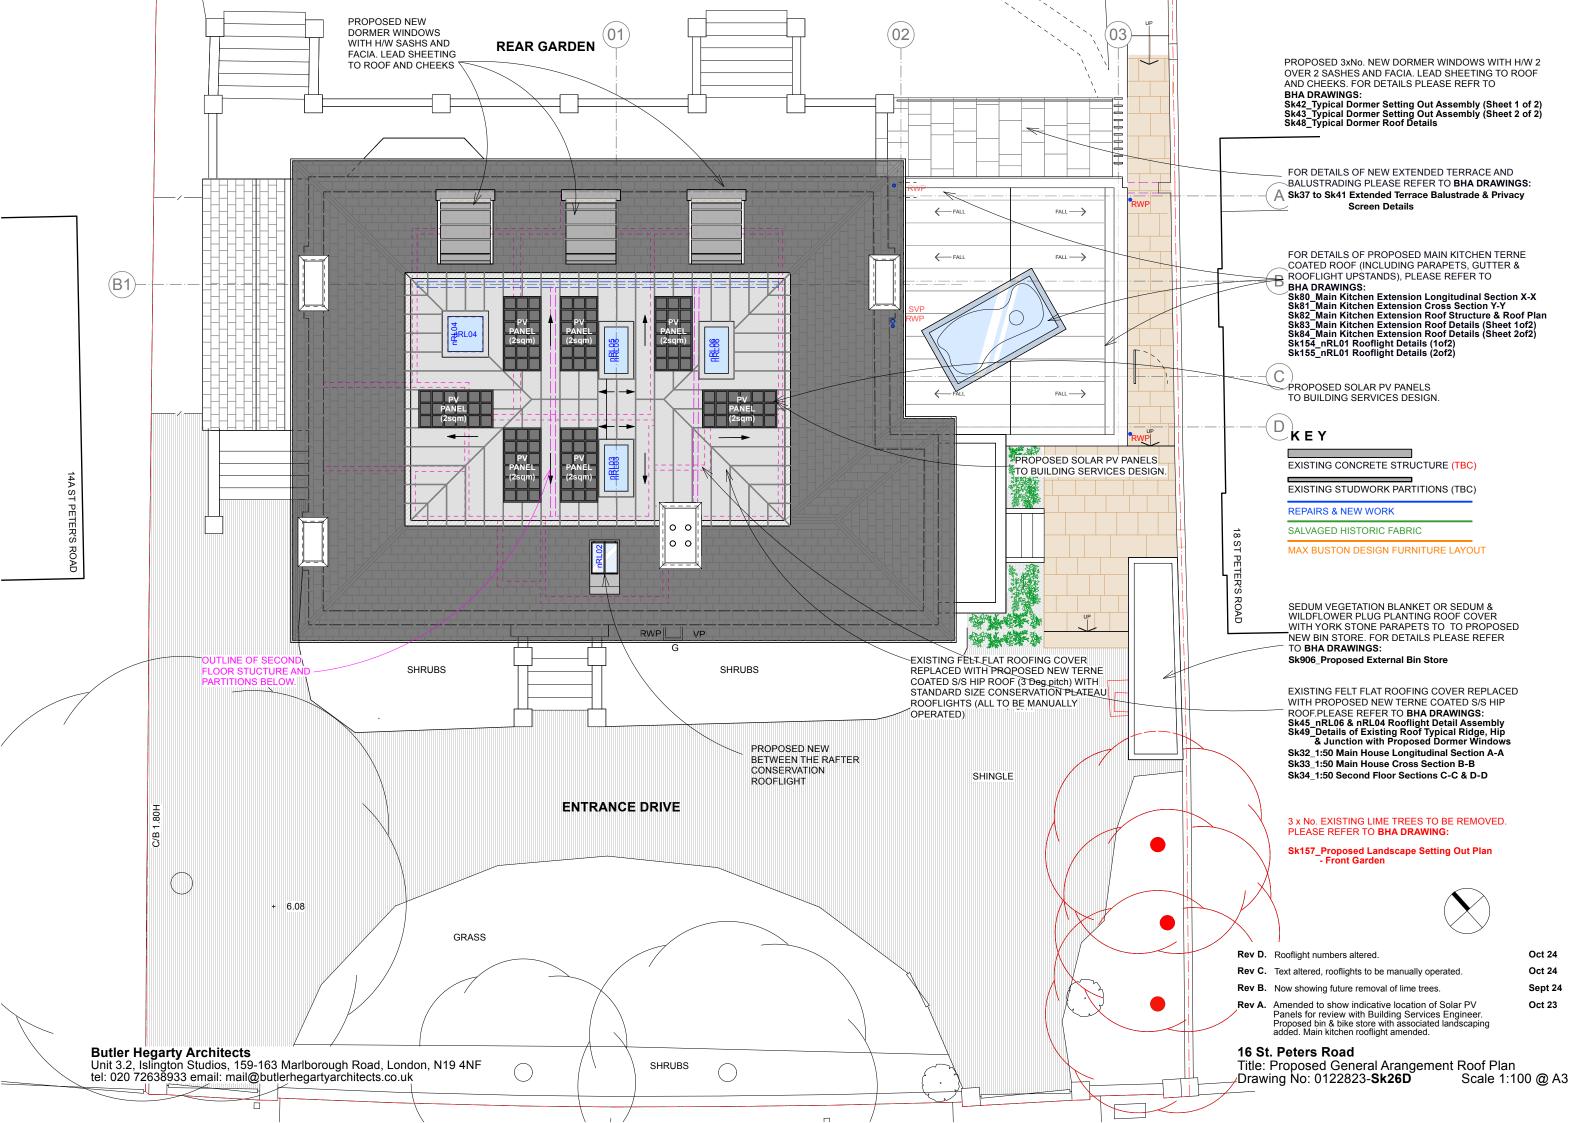

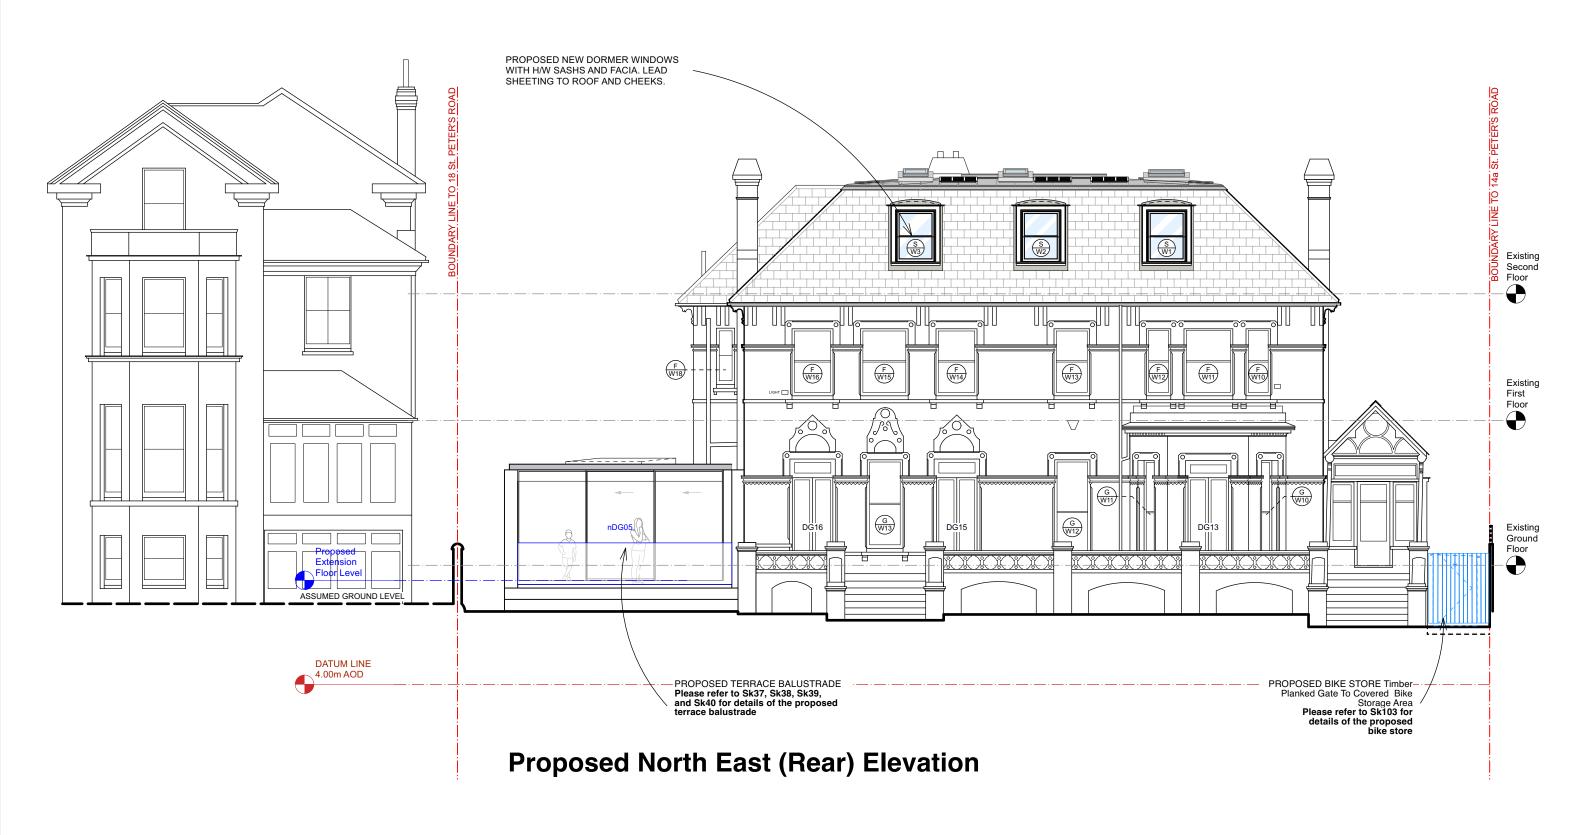

Rev A. Alterations shown in blue Oct 24

Butler Hegarty Architects

Unit 3.3, Islington Studios, 159-163 Marlborough Road, London, N19 4NF tel: 020 72638933 email: mail@butlerhegartyarchitects.co.uk

400mm 2m Scale 1:20


DO NOT SCALE


Rev A. Drawing updated & amended to discharge LBC/Planning conditions.


Jul 24

16 St. Peters Road

Title: Conservation Rooflight nRL02 Detail Assembly. Drawing No: 0122823-**Sk44A** Scale 1:20 @ A3

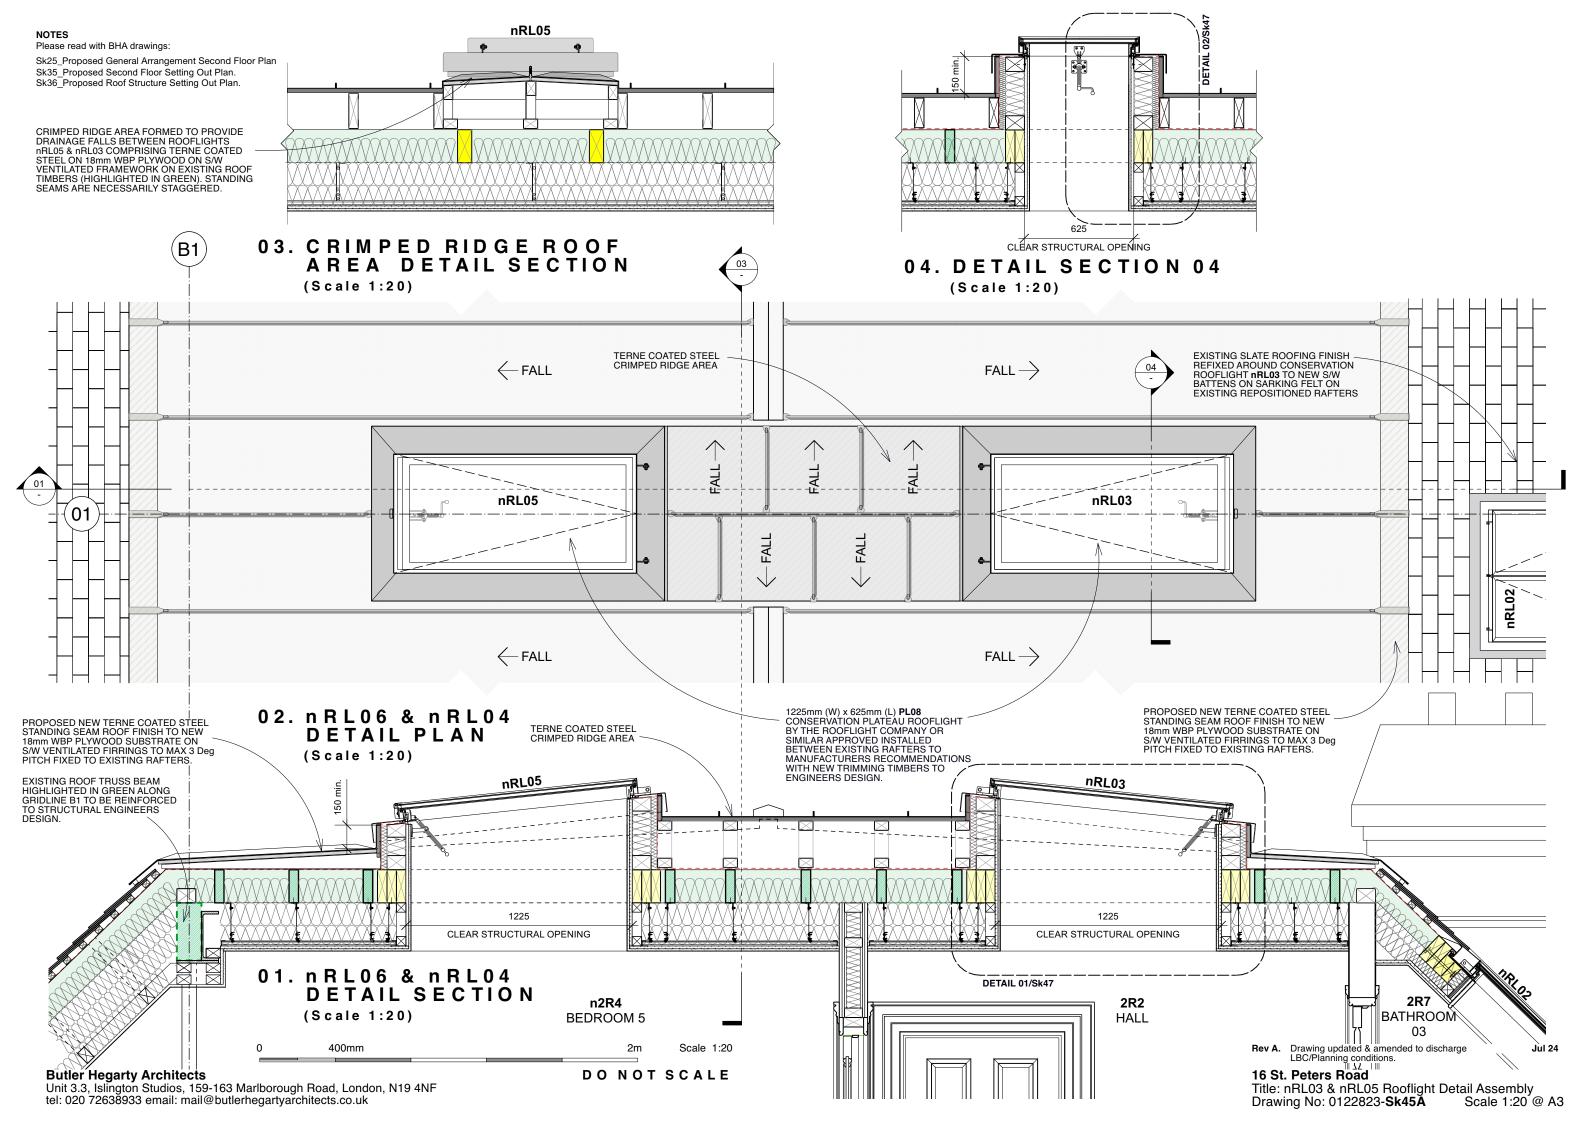

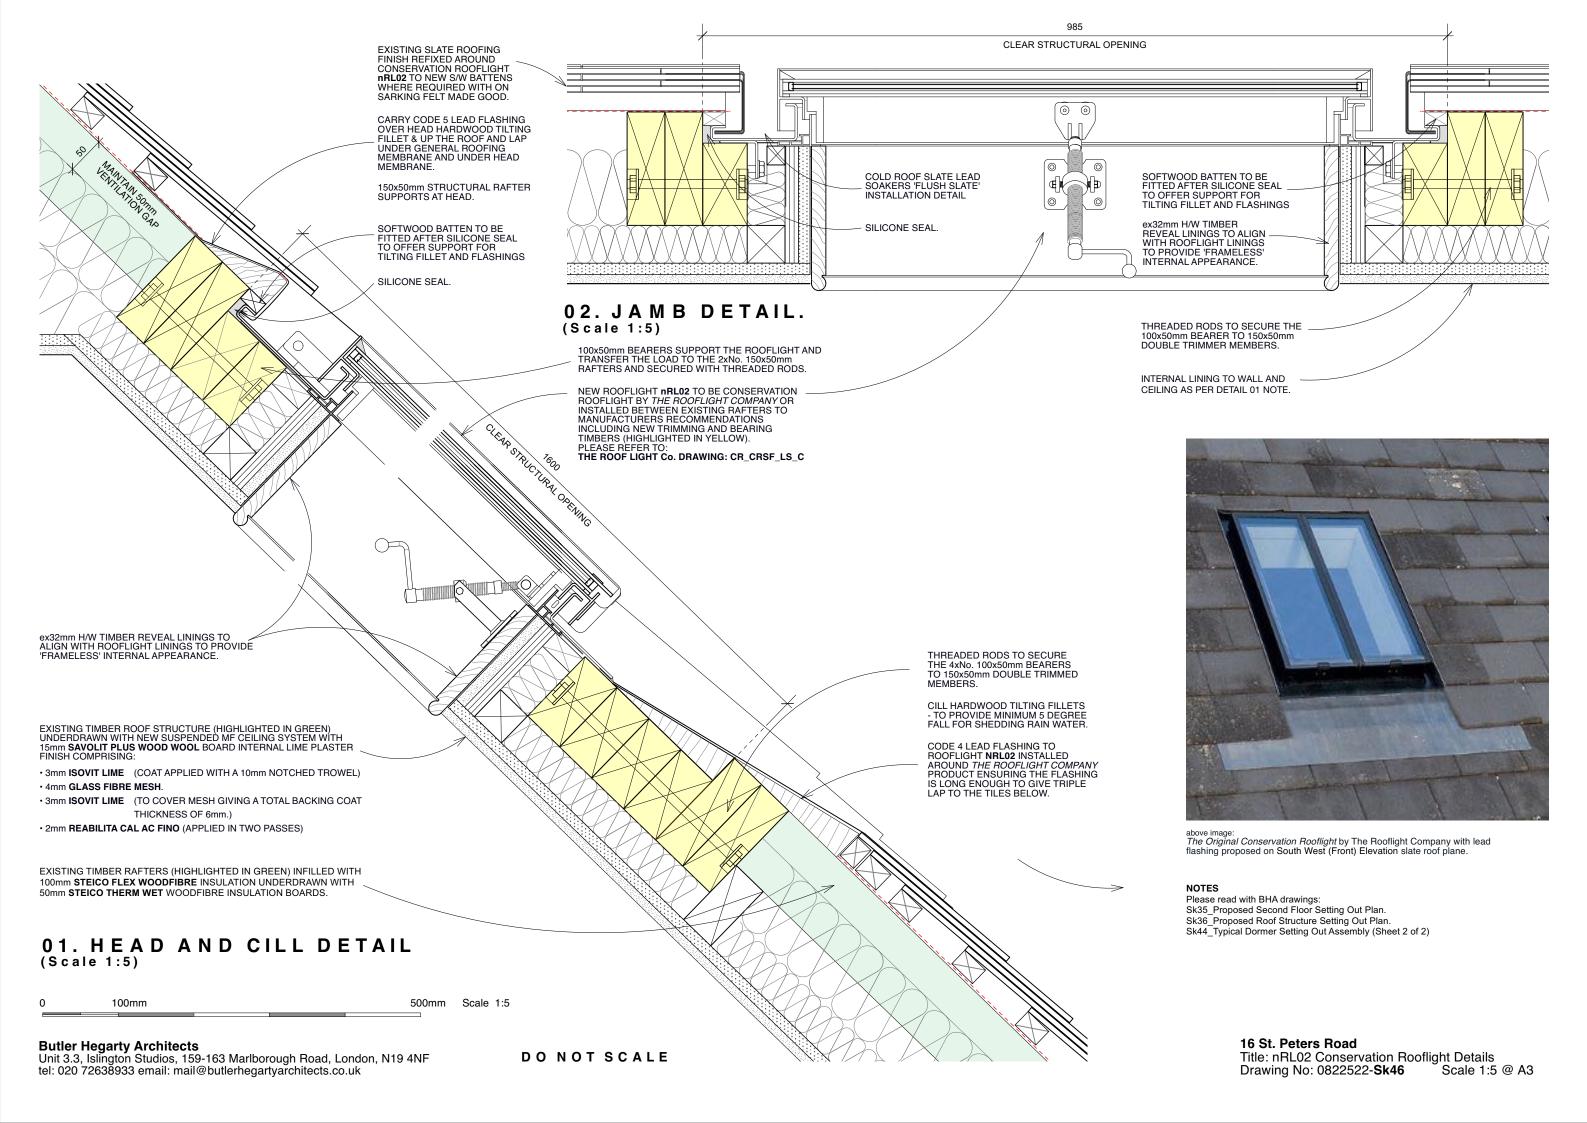

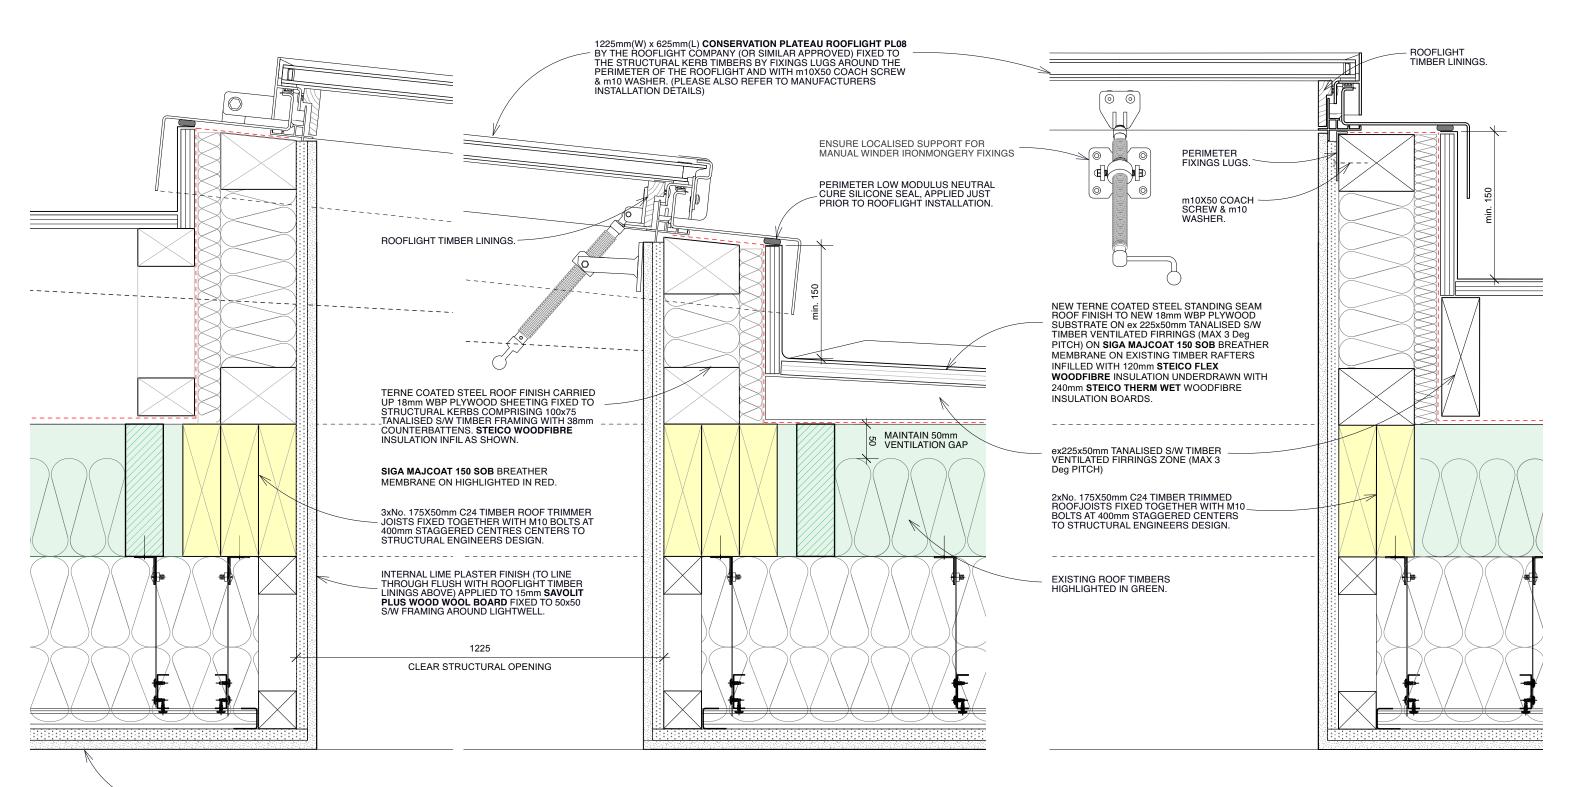

EXISTING TIMBER ROOF STRUCTURE (HIGHLIGHTED IN GREEN) UNDERDRAWN WITH NEW SUSPENDED MF CEILING SYSTEM WITH 15mm SAVOLIT PLUS WOOD WOOL BOARD INTERNAL LIME PLASTER FINISH COMPRISING:

- 3mm ISOVIT LIME (COAT APPLIED WITH A 10mm NOTCHED TROWEL)
- · 4mm GLASS FIBRE MESH.
- 3mm ISOVIT LIME (TO COVER MESH GIVING A TOTAL BACKING COAT THICKNESS OF 6mm.)
- 2mm REABILITA CAL AC FINO (APPLIED IN TWO PASSES)

01. HEAD AND CILL DETAIL (Scale 1:5)

100mm 500mm Scale 1:5

Butler Hegarty Architects
Unit 3.3, Islington Studios, 159-163 Marlborough Road, London, N19 4NF tel: 020 72638933 email: mail@butlerhegartyarchitects.co.uk



The Plateau Conservation Rooflight by The Rooflight Company proposed for the existing house new rooflights (Rooflight Ref: nRL03,04,05 & 06)

02. SIDE RAIL DETAIL (Scale 1:5)

NOTES
Please read with BHA drawings:
Sk35_Proposed Second Floor Setting Out Plan.
Sk36_Proposed Roof Structure Setting Out Plan.
Sk45_nRL03 & nRL05 Rooflight Detail Assembly

16 St. Peters Road

Title: Typical Plateau Conservation Rooflight Details Drawing No: 0822522-**Sk47** Scale 1:5 @ A Scale 1:5 @ A3