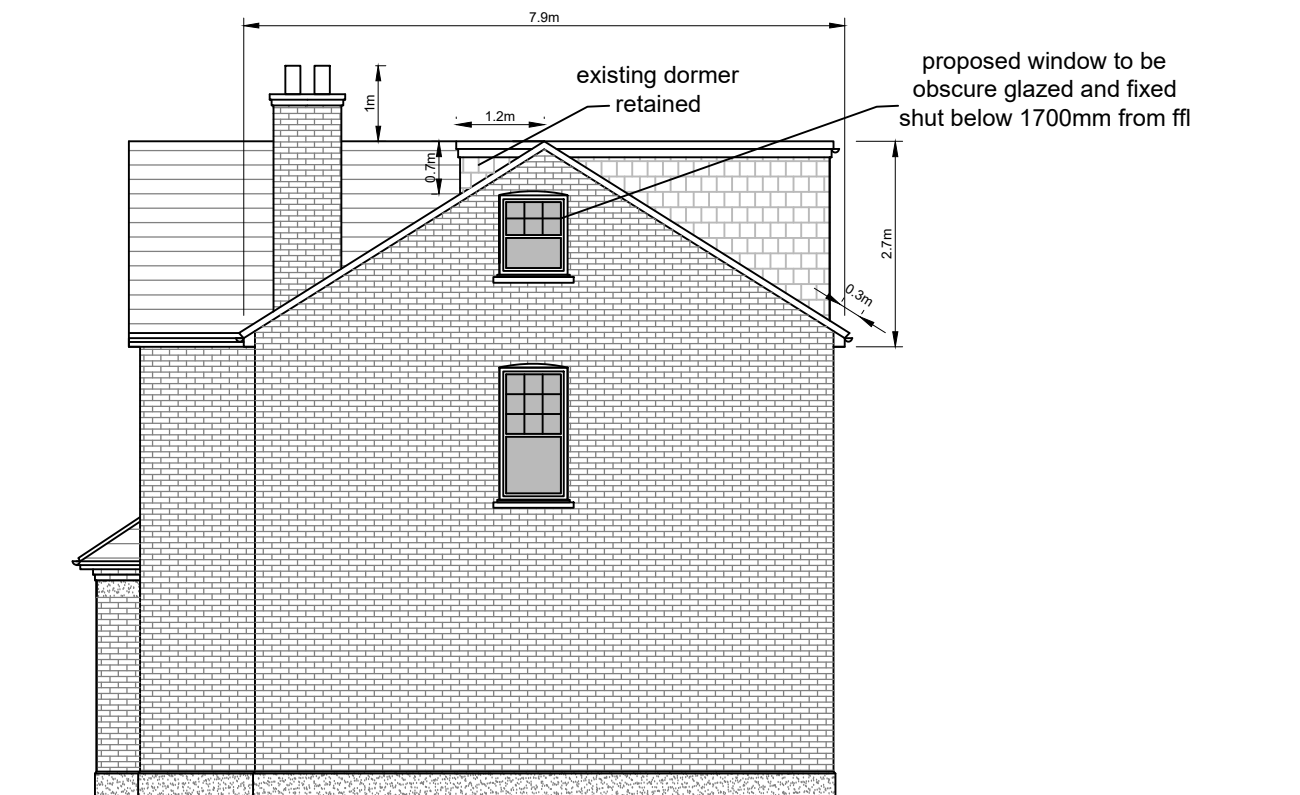




Proposed Front Elevation

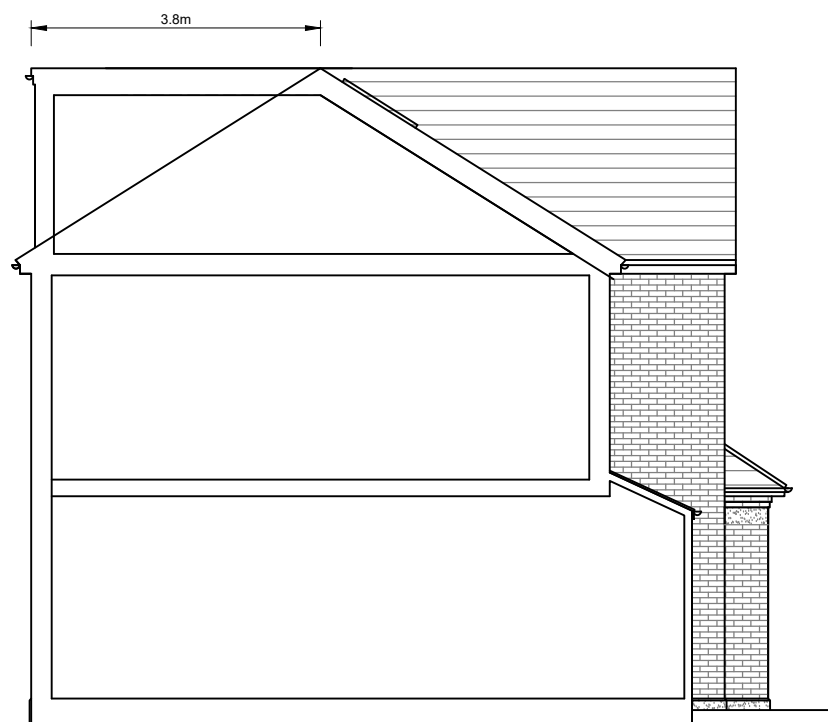


Proposed Side Elevation

Volume Calculations
 $5.8\text{m} \times 2.4\text{m} \times 3.8\text{m} / 2 = 26.44\text{m}^3$
 $7.9\text{m} \times 2.7\text{m} \times 2\text{m} / 6 = 7.11\text{m}^3$
 $2.1\text{m} \times 1.2\text{m} \times 0.7\text{m} / 2 = 0.88\text{m}^3$
 total = 34.43m³

Materials to match existing

Rev	Date	Description



Proposed Side Elevation



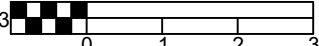
Proposed Rear Elevation



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Proposed Elevations

1: 100 @ A3 

Scale 1:100 @ A3	Dwg No. FLU.1425.3.05
Date 06.12.23	Rev F
Drawn JU	