


FRONT ELEVATION- BOUNDARY FENCING

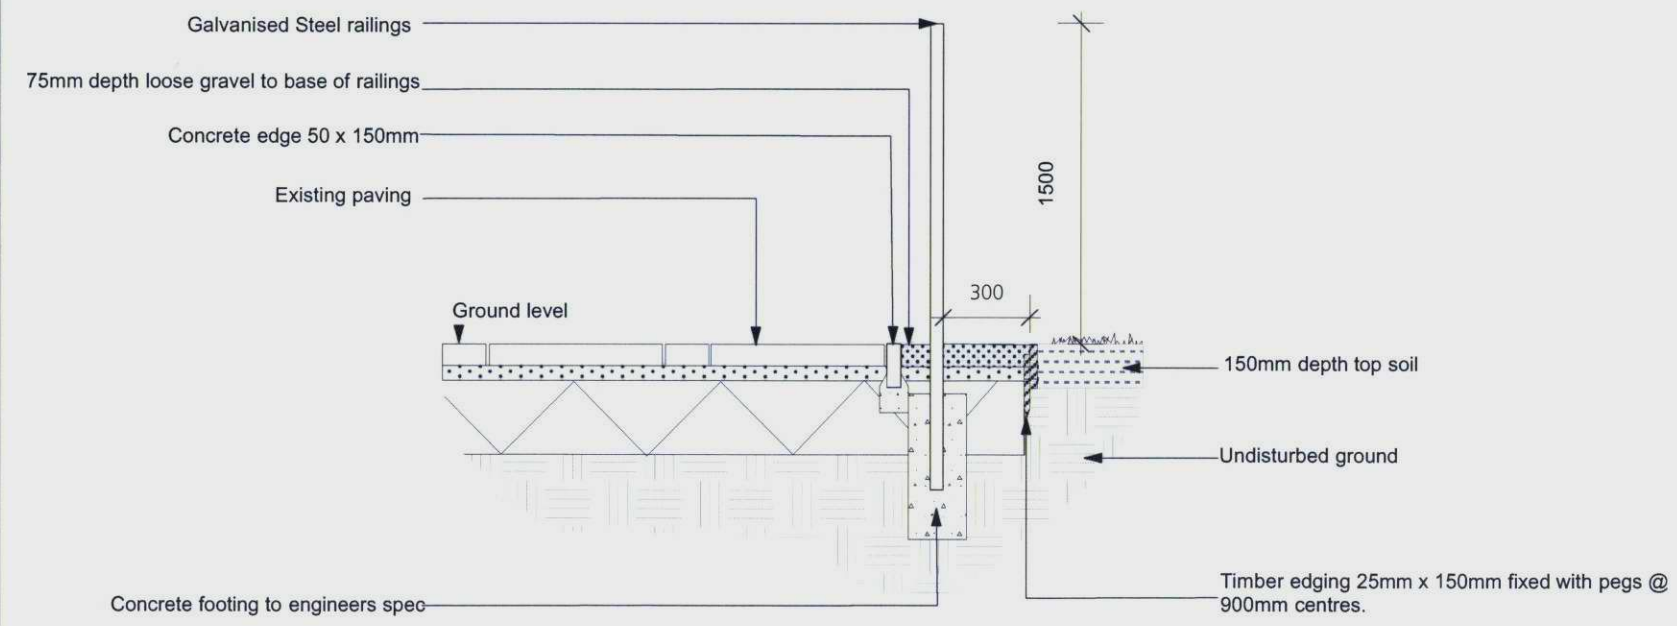

SECTION A'-A

KEY

Boundary Fence:
 Galvanised railings.
 Rails & anti-sag legs: 40x10 flat
 Bars: 16 Dia. round equally spaced bars max 100mm apart.
 Posts: 60 x 60 x 3 mm with flush welded caps.
 Bolts: galvanised cup square head bolts c/w nut & washer.

Overall height 1500mm above ground with upstand rods protruding through the top horizontal rail.
 2 No End panels at either end of fence to marry with existing walls at 2000mm height.
 1 set of matching double leaf swing gates each 1.5m wide.

All metalwork to be galvanised.
 All component and panel dimensions, fixtures & fittings to be confirmed for suitability by the fencing manufacturer.

All below ground details to engineers design.

NO.	DESCRIPTION	DATE	BY
A	Issued for Planning Approval	15.12.09	JN
A	Tender Issue		JN

- General notes:
1. This drawing is to be read in conjunction with other C&M landscape drawings and specifications.
 2. Any discrepancies between sources of information should be immediately notified to the Landscape Architect for clarification.
 3. Do not scale off this drawing.
 4. All dimensions in mm unless otherwise stated.

ST MARY'S UNIVERSITY COLLEGE	
SECTION A'- A BOUNDARY FENCING	
Tender	
SCALE: 1:25@A3	1155/101 B
DATE: 06.07.2009	
DRAWN: JN	

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